CAMP TIMANOUS DINING HALL

85 PLAINS RD, RAYMOND, ME 04071

BULLETIN 1 DATE OF ISSUE: 05/10/2024

PROJECT TEAM

ARCHITECT Simons Architects 75 York Street Portland, ME 04101

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STRUCTURAL ENGINEER Trillium Engineering Group 189 Main Street Suite 200 Yarmouth, ME 04096

KITCHEN CONSULTANT TJM CONSULTING, INC. 2 Main Street, Suite 17-301C Biddeford, Maine 04005

Thomas J McArdle (207) 215-4736 tom@tjmconsulting.net

CIVIL ENGINEER Trillium Engineering Group 189 Main Street Suite 200 Yarmouth, ME 04096


PROJECT DESCRIPTION

This project involves the removal and replacement of the existing kitchen, deck, and expansion of the dining room at the historic Camp Timanous dining hall. The existing building is used seasonally, only during the summer, and has no heating or cooling systems. No additional systems are proposed as part of this scope of work.

ALTERNATE

Pending Town of Raymond's revision to Fire Protection Ordiance, NW corner would be enclosed for interior storage space. Base bid keeps this space exterior covered porch as documents in the rest of the darwings.

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MATER		ARCHITE	CTURAL S	YMBOLS
	COURSE GRAVEL	SYMBOL LE	GEND	PROPOSED ELEVATIO
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	STONE		101	BUILDING SECTION
	EARTH/COMPACT FILL	DOOR NUMBER	(101A)	
	GYPSUM/PLASTER	WINDOW NUMBER	101A	BUILDING ELEVATION
	PLYWOOD	PARTITION TYPE	A3>	
	FINISH WOOD	PLUMBING FIXTURE	PF->	WALL SECTION
	ROUGH WOOD			
	BLOCKING WOOD	EQUIPMENT/ ACCESSORY TAG	AC-	
	CONCRETE MASONRY	FLOOR FINISH	WD	INTERIOR ELEVATION
	BRICK MASONRY	WALL/BASE FINISH	XY_	
	SAND/FINE GRAVEL		AB	COLUMN REFERENCE
	DENSE PAK CELLULOSE INSULATION	FINISH TAG	WD	
	SPRAY FOAM INSULATION	KEYNOTE		REVISION REFERENC
	BATT INSULATION			
	XPS INSULATION	DETAIL		NEW DOOR
	EPS INSULATION			

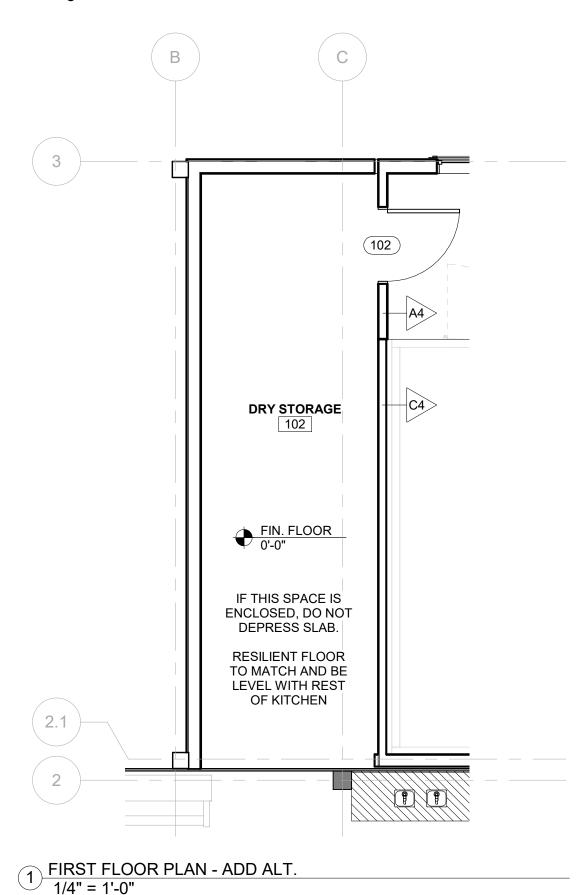

DRAWING LIST

• FIRST	ISSUANCE	IONS	
SHEET NO.	SHEET NAME	03.30.2024 - IFC	05.10.2024 - BULLETIN 1
GENERAL			
GENERAL G001	COVER SHEET	•	
G101	LIFE SAFETY PLAN + CODE SUMMARY		-
G110	PARTITION TYPES & TYP. MOUNTING	•	_
G111	ACCESSIBILITY DIAGRAMS		
G200	EXISTING CONDITIONS - PHOTOGRAPHS	•	_
G201	EXISTING CONDITIONS - PHOTOGRAPHS	•	
CIVIL			
C001	(CIVIL) COVER SHEET EXISTING CONDITIONS PLAN	•	
C100 C101	SITE PLAN	•	-
C200	SITE PLAN SITE DETAILS	•	-
C300	EROSION CONTROL DETAILS	•	
DEMOLITION DM101	DEMOLITION PLAN - LEVEL 01	•	
ARCHITECTUR	AL		
A000	ARCHITECTURAL SITE PLAN	•	
A101	CONSTRUCTION PLAN	٠	-
A102	ROOF PLAN	•	-
A121	FINISH PLAN	•	
A131	REFLECTED CEILING PLAN	•	-
A151	ENLARGED PLANS & INT. ELEVS.	•	
A201	EXTERIOR ELEVATIONS NORTH AND WEST	•	-
A202	EXTERIOR ELEVATIONS SOUTH AND EAST	•	-
A301	BUILDING SECTIONS	•	-
A302	BUILDING SECTIONS	•	-
A310	WALL SECTIONS	•	

ISSUED WITH	H REVISIONS & REMOVED F	FROM SET	
SHEET NO.	SHEET NAME	03.30.2024 - IFC	05.10.2024 - BULLETIN 1
A311	WALL SECTIONS	•	
A401	VERTICAL CIRCULATION	•	
A501	DETAILS	•	
A600	SCHEDULES	•	•
STRUCTURAL			
S0.0	STRUCTURAL NOTES	•	
S1.0	FOUNDATION PLAN	•	
S1.1	FIRST FLOOR FRAMING PLAN	•	
S1.2	ROOF FRAMING PLAN	•	
S2.0	TYPICAL FOUNDATION DETAILS	•	
S3.0	TYPICAL FRAMING DETAILS	•	
FOODSERVICE			
FS1	PLAN & SCHEDULE	•	-
FS2	ELECTRICAL PLAN	•	-
FS3	PLUMBING PLAN	•	
FS4	ELEVATIONS	•	
FS5	ELEVATIONS	•	
FS6	HOOD DETAIL 1	•	
FS7	HOOD DETAIL 2	•	
FS8	HOOD DETAIL 3	•	
FS9	HOOD DETAIL 4	•	
FS10	HOOD DETAIL 5	•	
FS11	HOOD DETAIL 6	•	
FS12	HOOD DETAIL 7	•	
FS13	HOOD DETAIL 8	•	
FS14	HOOD DETAIL 9	•	
FS15	WALK-IN DETAIL	•	

AR AB ACT

ADDL ADJ

AFF

ALUM ALT

APV

ARCH

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CAB

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CIRC CJ

CL CLG CLO CMU CO COL

CONC C CONST C CONT C COOR C

COORD C

CRS CT

CTV


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BLDG BL

BLKG


BRG BTW

ADMIN

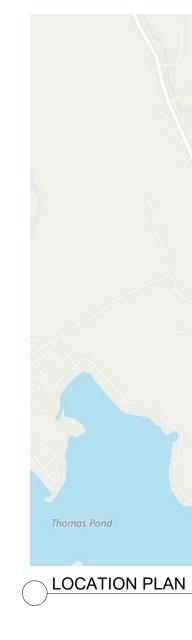


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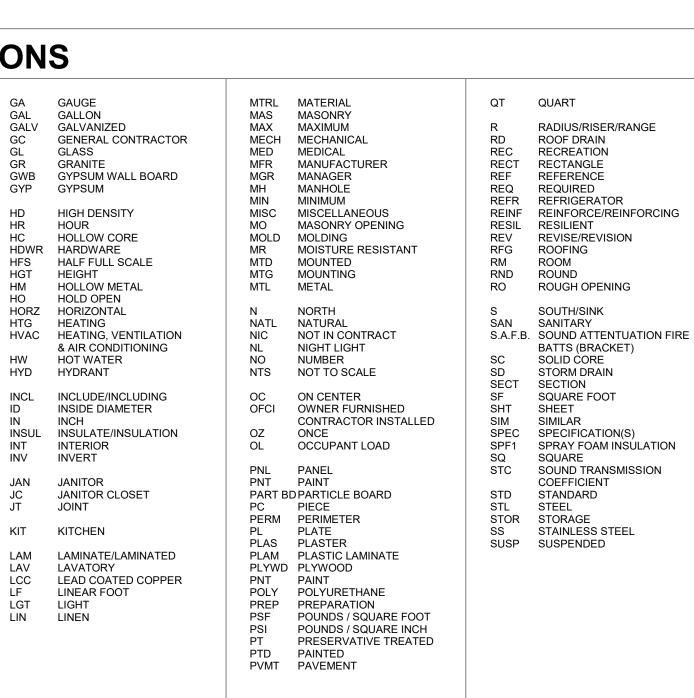
MBOLS

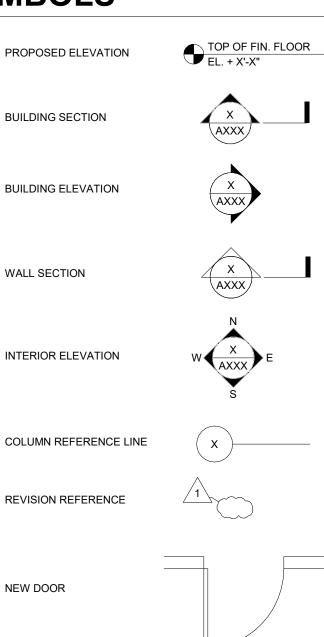

ARCHITECTUAL ABBREVIATIONS

ABUSE RESISTANT ANCHOR BOLT ACOUSTICAL CEILING TILE ADJITIONAL ADJACENT ADMINISTRATION ABOVE FINISH FLOOR ALUMINUM ALTERNATE ACCESS PANEL (APPROXIMATE(LY) ASPHALT PAVER ARCHITECT	D DRYER DBL DOUBLE DEFL DEFLECTION DEMO DEMOLITION DF DRINKING FOUNTAIN DIA DIAMETER DIAG DIAGONAL DIM DIMENSION DR DIRECTOR/DOOR DIV DIVISION DN DOWN DTL DETAIL DWG DRAWING
BOARD BOTTLE FILLER BITUMINOUS BUILDING BLOCKING BENCHMARK BEARING BETWEEN CABINET CATCH BASIN CEMENT CUBIC FEET CORNER GUARD CIRCLE/CIRCULAR CONTROL JOINT CENTER LINE CEILING CLOSET CONCRETE MASONRY UNIT CLEAN OUT COLUMN CONCRETE CONCRETE CONSTRUCTION CONTINUE, CONTINUOUS CORRUGATED D COORDINATED COURSE CERAMIC TILE CABLE TELEVISION LINE CABINET UNIT HEATER CUBIC YARD	E EAST EA EACH EF EXHAUST FAN EJ EXPANSION JOINT EL ELEVATION ELEV ELEVATOR ELEC ELECTRIC/ELECTRICAL EQ EQUAL EWC ELECTRIC WATER COOLER EXAM EXAMINATION EXIST EXISTING EXT EXTERIOR FBO FURNISHED BY OWNER FCO FLOOR CLEAN OUT FD FLOOR DRAIN FCP FIRE CONTROL PANEL FE FIRE EXTINGUISHER FEC FIRE EXTINGUISHER FEC FIRE EXTINGUISHER FEC FIRE EXTINGUISHER FEC/FR FEC, SEMI RECESSED FEC/FR FEC, SEMI RECESSED FEC/FR FEC, SEMI RECESSED FG FIBERGLASS FIN FINISH FL FLOOR FOS FACE OF STUD FRP FIBERGLASS REINFORCED PLASTIC FT FOOT FTG FOOTING F.O. FACE OF



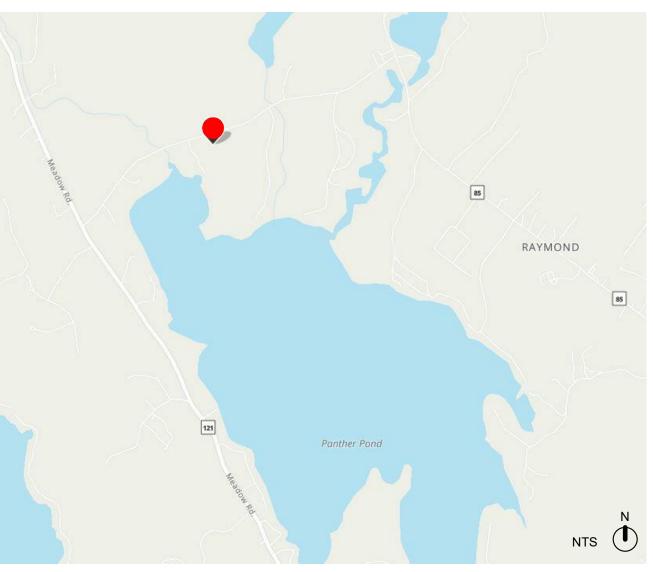



75 York Street Portland, Maine 04101 simonsarchitects.com 207.772.4656

PROJECT NAME: CAMP TIMANOUS **DINING HALL**

85 PLAINS RD, RAYMOND, ME 04071

SEAL:



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2 BULLETIN 1

05.10.24

05/10/2024 DATE OF ISSUE: 2023-0050 PROJECT NUMBER: STATUS: **BULLETIN 1**


COVER SHEET

G001

LIFE SAFETY NOTES: THESE LIFE SAFETY PLANS ARE MEANT TO SHOW CONFORMANCE WITH THE 1. REGULATIONS EXISTING AT THE TIME OF CONSTRUCTION, OR AS INDICATED IN THE CODE SUMMARY NOTES. THESE DOCUMENTS ARE A COMPILATION OF EXISTING CONSTRUCTION DOCUMENTS, EXISTING CONDITIONS AS OBSERVED IN THE FIELD, AND CURRENT PROGRAMMATIC USE STATEMENTS. AN AS-BUILT SURVEY WAS NOT CONDUCTED FOR THE COMPLETION OF THESE DRAWINGS; SOME CONDITIONS MAY DIFFER FROM THOSE SHOWN.

- SEE G110 FOR PARTITION TYPES 2.
- SEE ENLARGED PLANS AND INTERIOR ELEVATIONS FOR MOUNTING HEIGHTS OF F.A. -3 DEVICES AND LIFE SAFETY SYSTEMS.
- WHERE THERE ARE DISCREPANCIES BETWEEN IBC AND NFPA, THE MOST RESTRICTIVE 4. SHALL BE USED.

LIFE SAFETY PLAN LEGEND:

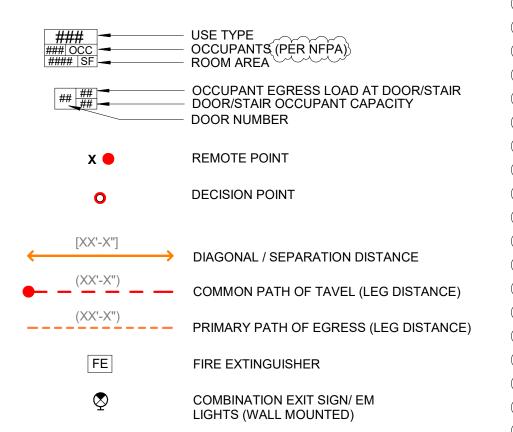

OCCUPANCY CLASSIFICATION

ASSEMBLY

KITCHEN


OCCUPANT LOAD CALCULATIONS IBC TABLE 1004.1.2					OCCUPANT LOAD CALCULATIONS NPFA 101: TABLE 7.3.1.2 OCCUPANT LOAD FACTOR						
OCC.	USE	NET OR GROSS	AREA	LOAD FACTOR	LOAD	occ.	USE	NET OR GROSS	AREA	LOAD FACTOR	LOAD
A-2	COVERED PORCH [†]	NET	938	5 SQF /PERSON	188 [†]	ASSEMBLY	COVERED PORCH†	NET	938	7 SQF /PERSON	136 †
A-2	DINING HALL	NET*	3010*	15 SQF /PERSON	201	ASSEMBLY	DINING HALL TABLES	NET*	2897*	15 SQF /PERSON	194
A-2	KITCHEN	GROSS	1032	200 SQF /PERSON	6	ASSEMBLY	DINING HALL STANDING	NET	113	7 SQF /PERSON	17
S-1	STORAGE	GROSS	22	300 SQF /PERSON	1	ASSEMBLY	KITCHEN	GROSS	1032	100 SQF /PERSON	11
S-2	FOOD STORAGE	GROSS	470	300 SQF /PERSON	2	STORAGE	STORAGE	GROSS	470	500 SQF /PERSON	3
					210 [†]						225 [†]

EGRESS CAPACITY (DOORS) IBC 1005.5.3.2

DOOR	LOAD		CAPACITY		DOOR	OOR LOAD			
DOON	20/15	WIDTH	FACTOR	CALC.			WIDTH	FACTOR	CALC.
109	81	68"	.2	340	109	85	68"	.2	340
110	81	68"	.2	340	110	85	68"	.2	340
103A	8	68"	.2	340	103A	13	68"	.2	340
101C	40	34"	.2	170	101C	42	34"	.2	170
TOTAL	210	l l		1,190	TOTAL	225			1,19

TRAVEL DISTANCE IBC TABLE 1006.2.1

REMOTE	EGRESS	СОММО	N PATH	TOTAL DISTANCE	OTAL DISTANCE				EGRESS	СОММО	COMMON PATH		TOTAL DISTANCE	
POINT	POINT	ALLOWED	PROVIDED				POINT POINT	ALLOWED*	PROVIDED	ALLOWED*	PROVIDED			
A	110	100'	6'-4"	66'-0"		A	110	75'-0"	6'-4"	200'-0"	66'-0"			
А	101C	75'-0"	6'-4"	31'-0"		А	101C	20'-0"	6'-4"	200'-0"	31'-0"			
В	103A	75'-0"	4'-6"	33'-6"		В	103A	50'-0"	25'-3"	200'-0"	64'-7"			
В	101C	100'-0"	17'-6"	24'-1"		В	101C	50'-0"	25'-3"	200'-0"	104'-5"			

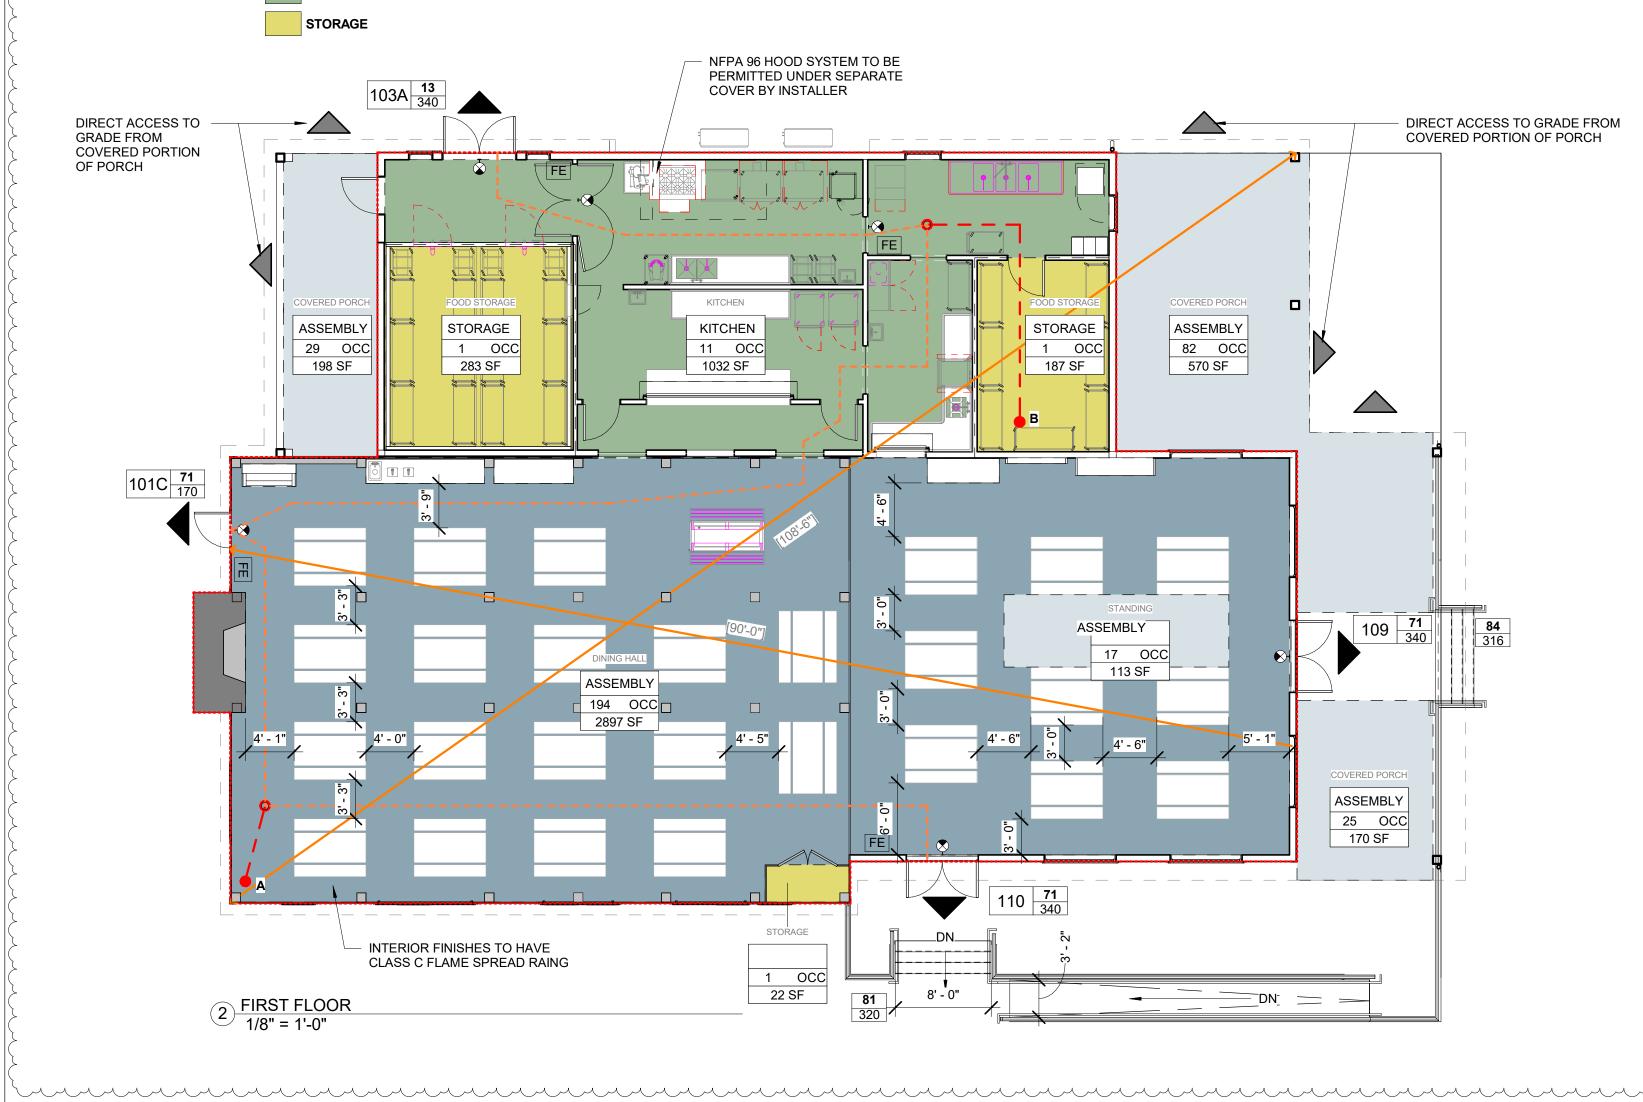


* THIS NUMBERS DOES NOT SUBTRACT TABLES AND CHAIRS † COVERED PORCHES ARE EXTERIOR SPACE AND NOT INCLUDED IN BUILDING LOAD TOTAL


> EGRESS CAPACITY (DOORS) OCC BY NPFA 1 7.3.1.2 / EGRESS WIDTH BY IBC 1005.3.2

TRAVEL DISTANCE NFPA TABLE A.7.6

Addres	-		85 PLAINS RD, RAYMOND, ME 04
	of Construction ancy Type	1:	VB (Unprotected Co A-2 Dining Facilities Existing Assembly (
Bldg Ai New C Delta /	rea, Pre-Renov rea, Post-Renov onstruction Are Area Added:	vation: a:	3450 sf 4783 sf 2,829 sf 1333 sf (38.6% of P /B, Non-sprinklered p
			/ Allowable per IBC 5
COD	E SUMMAR	<u> </u>	
	CABLE CODES nd's Adopted C 2015 Internat	ode / MUB	EC: ding Code (IBC)
	Fire/ Life Safe	ety	
			ty Code as adopted b t limited to:
		A 1 2018	
	NFP/ Accessibility	A 101 2018	: Life Safety Code
		ADA Stan	dards for Accessible
	Fire Protection		
NOTE:	All Codes shal	l include ch	anges/amendments
OCCU IBC 30	PANCY CLASS 2_	SIFICATIO	N AND LOAD
	Assembly Assembly Assembly Storage	A-2 A-2 A-2 S-2	Assembly v Kitchen as Assembly v [Accessory
<u>NFPA</u>	7.3.1.2 Assembly Assembly Assembly Storage		Less conce Kitchen Concentrat Other than
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PANTHER POND



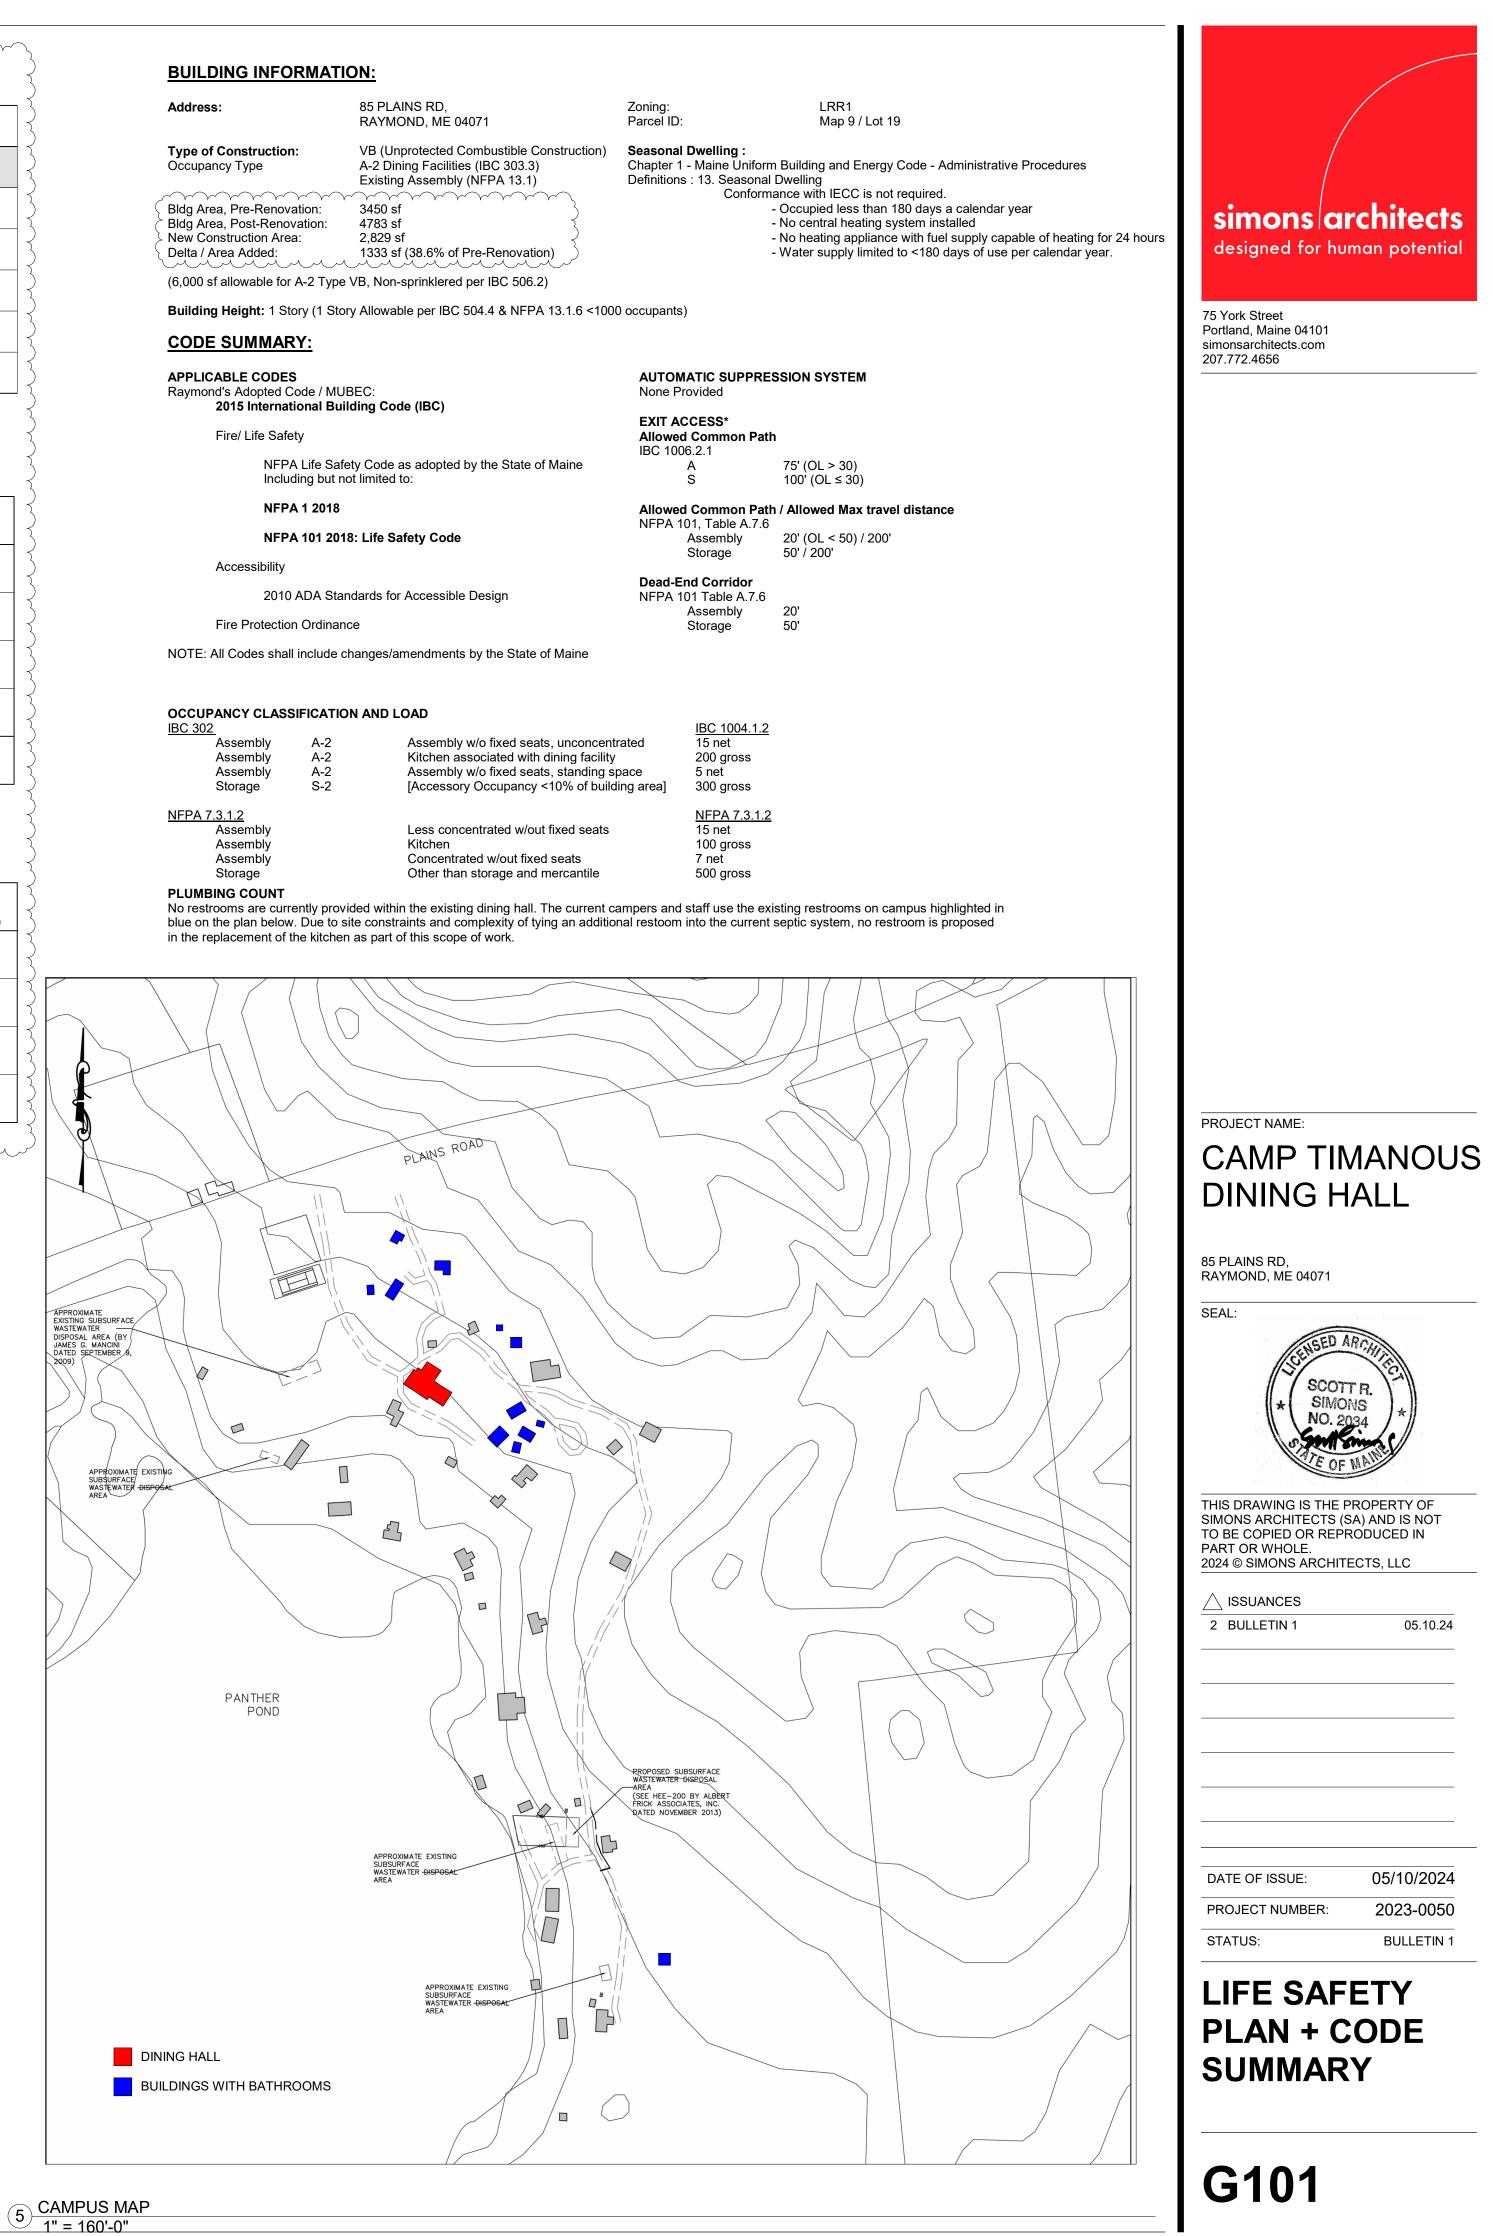

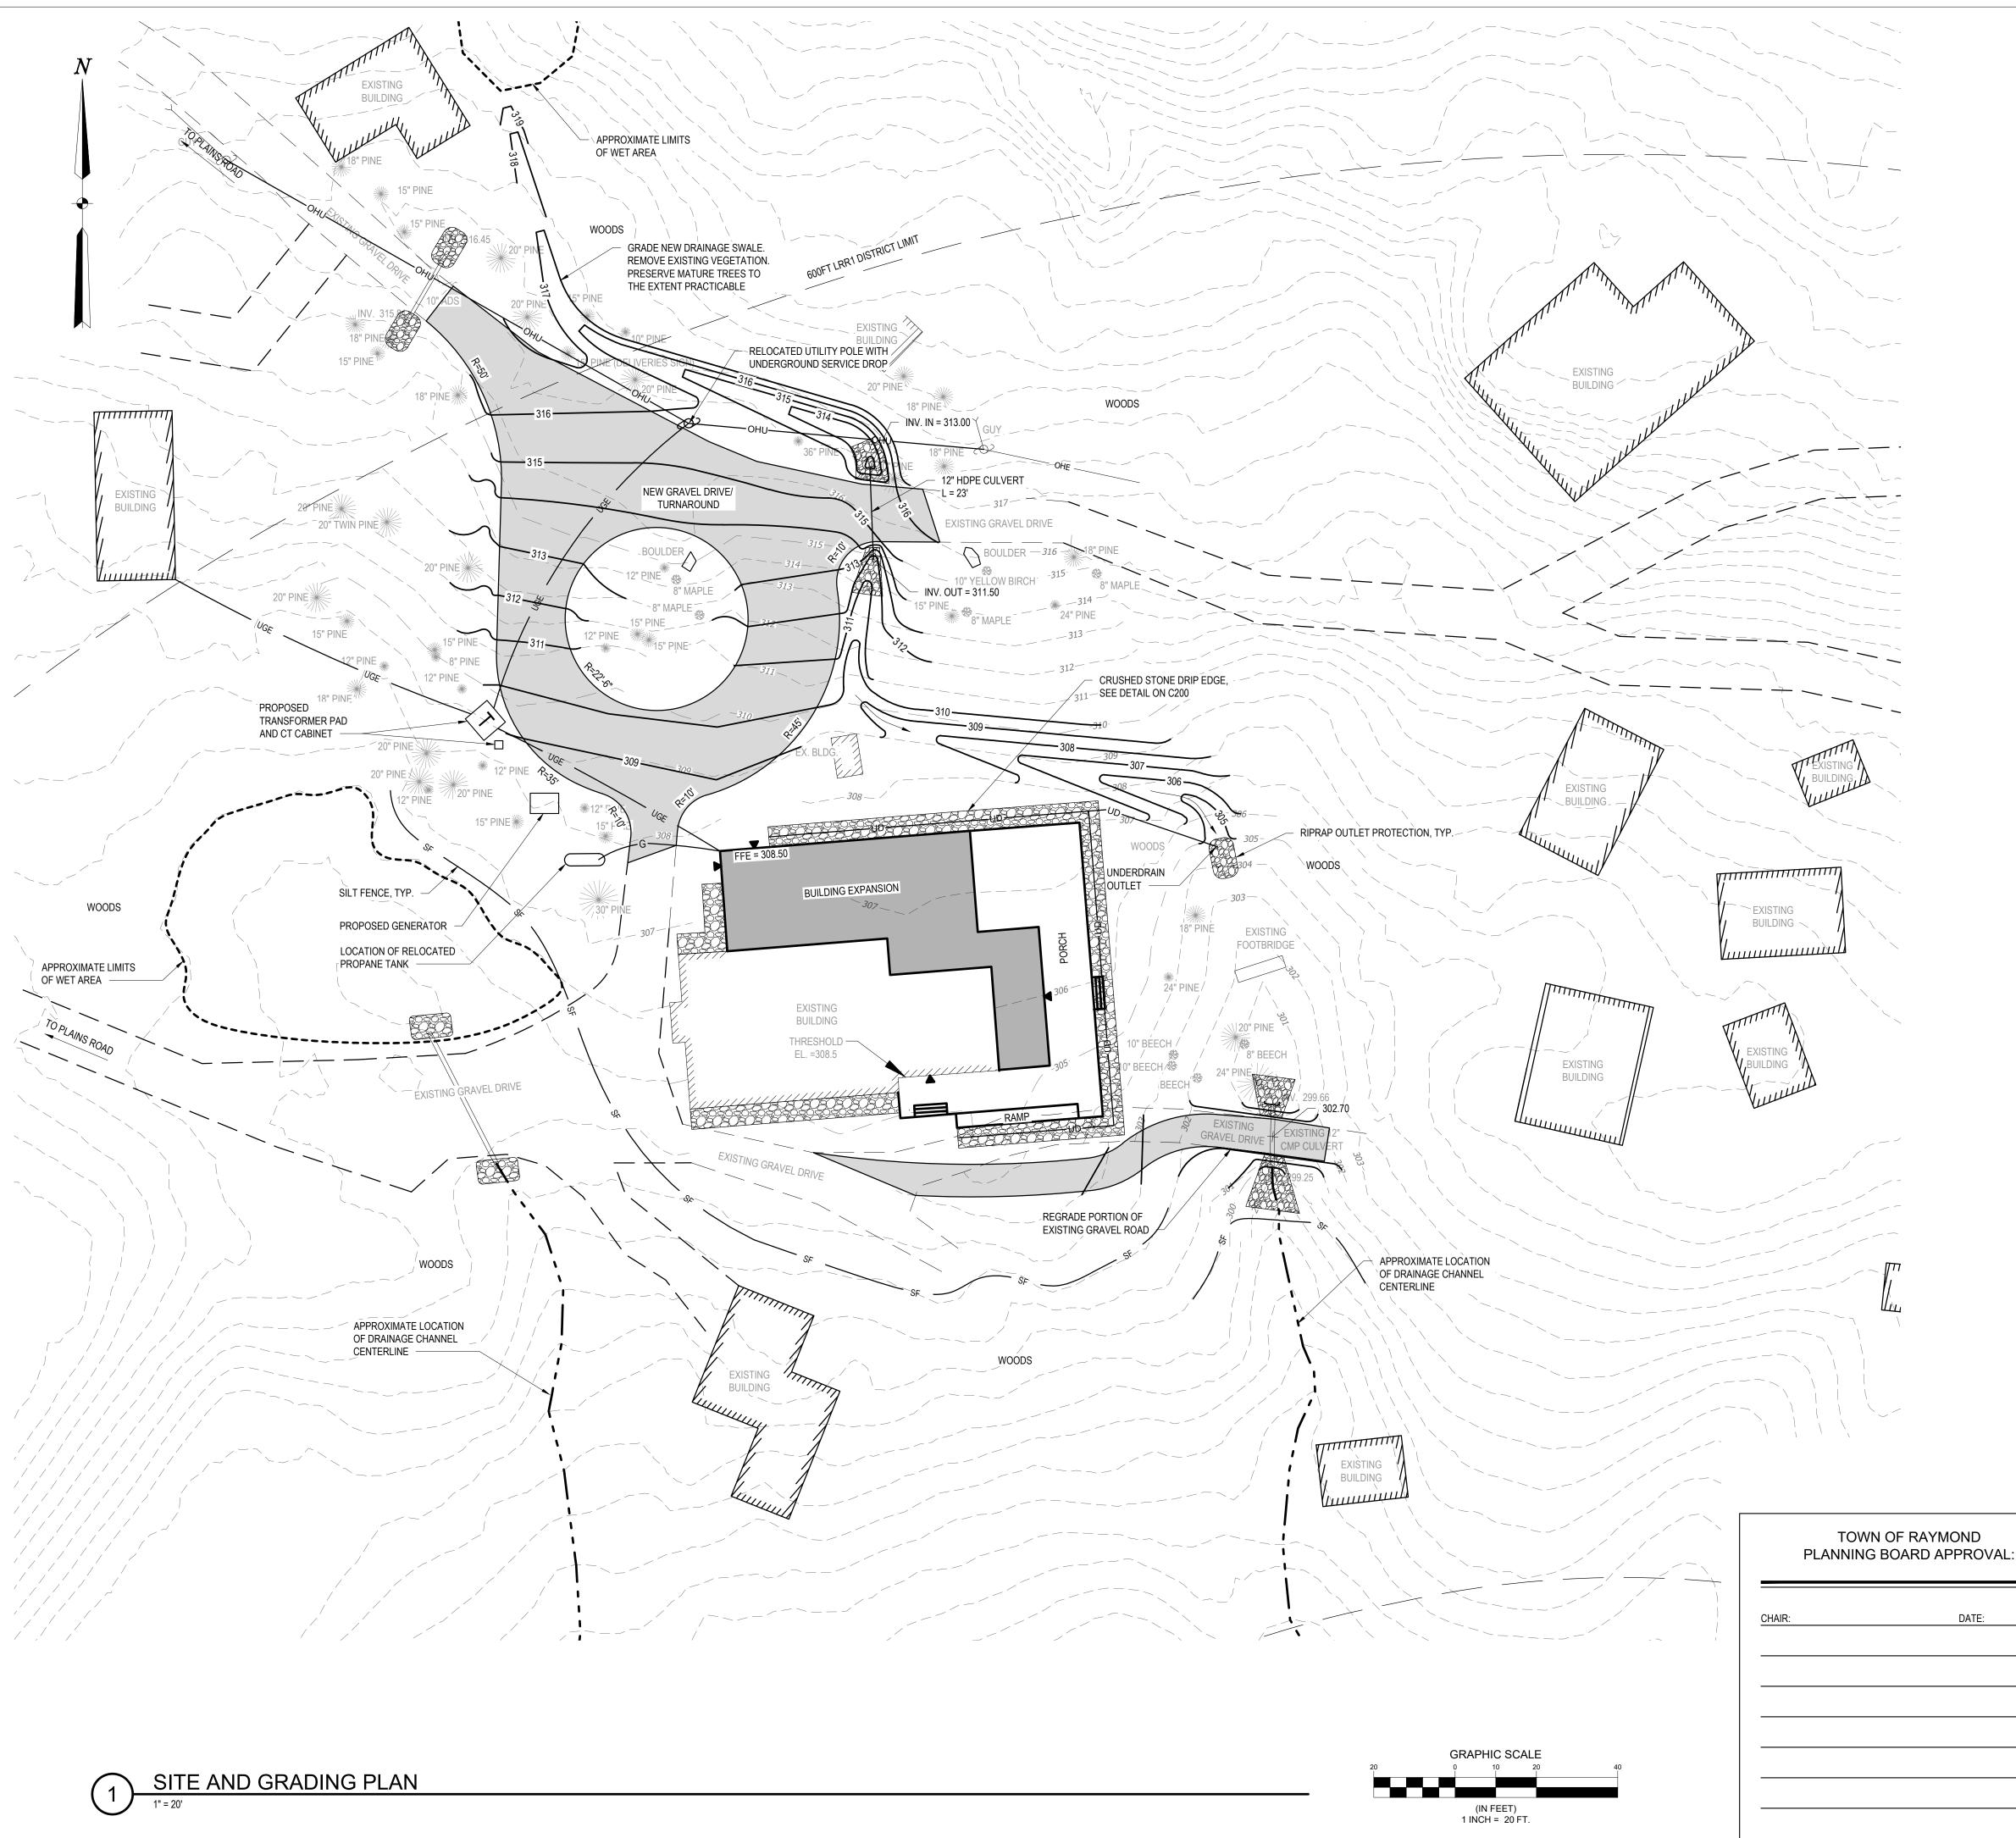

GENERAL NOTES

1. LOCATIONS OF UTILITIES ARE APPROXIMATE

- 2. IT SHALL BE THE CONTRACTOR'S RESPONSIBILITY TO HAVE EACH UTILITY COMPANY LOCATE THEIR INDIVIDUAL SERVICES PRIOR TO THE START OF CONSTRUCTION.
- 3. ALL THE UTILITY WORK SHALL BE DONE BY OTHERS.
- 4. PROPERTY MARKERS AND STREET LINE MONUMENTS SHALL BE PROPERLY PROTECTED AND SHALL NOT BE DISTURBED. IF DISTURBED, THEY SHALL BE REPLACED BY A LICENSED SURVEYOR AT THE CONTRACTOR'S EXPENSE.
- 5. ALL EXISTING CATCH BASINS, MANHOLES, CONNECTIONS, AND OUTLET PIPING SHALL BE CLEANED AND LEFT IN SATISFACTORY OPERATING CONDITION AFTER CONSTRUCTION HAS BEEN COMPLETED. NO SEPARATE PAYMENT WILL BE MADE FOR THIS WORK.
- 6. ALL LAWN AREAS, WALKWAYS, AND DRIVEWAYS OUTSIDE THE WORK AREA, DAMAGED BY THE CONTRACTOR, SHALL BE REPAIRED BY THE CONTRACTOR AT NO EXPENSE TO THE TOWN.
- 7. THE CONTRACTOR SHALL BE RESPONSIBLE FOR THE PRESERVATION OF ALL TREES AND SHRUBS ON THE PROJECT
- WHICH ARE NOT REMOVED. 8. EXISTING PAVEMENT SHALL BE SAW CUT AND BUTTED TO THE NEW PAVEMENT. NO FEATHERING OF PAVEMENT WILL
- BE PERMITTED.

9. EXISTING DRAINAGE STRUCTURES SHALL NOT BE DISTURBED UNLESS OTHERWISE NOTED. 10. ALL EXISTING DRAINAGE PIPES TO BE ABANDONED SHALL BE PLUGGED WITH CONCRETE OR AS DIRECTED BY THE PROJECT ENGINEER.


11. NO ADDITIONAL PAYMENT WILL BE MADE FOR GRADING SIDE SLOPES OF DRIVEWAYS. 12. THE CONTRACTOR SHALL BE RESPONSIBLE FOR REPAIRING ANY TRENCH PAVEMENT THAT HAS EXPERIENCED EXCESSIVE SETTLEMENT, CRACKING, OR OPENING OF JOINTS, REPAIRS MAY INCLUDE OVERLAY, REMOVAL OF UNACCEPTABLE MATERIALS, COMPLETE REPLACEMENT, JOINT SEALING, OR REBUTTING PAVEMENT AS REQUIRED. THIS WORK MAY BE NECESSARY <u>AFTER THE FINAL ACCEPTANCE</u> OF WORK OR PRIOR TO THE END OF THE ONE YEAR GUARANTEE. THIS WORK SHALL BE DONE AT THE CONTRACTOR'S EXPENSE.

- 13. ALL MANHOLE FRAMES SHALL BE SUPPLIED WITH SOLID MANHOLE COVERS; SEE STANDARD DETAIL.
- 14. NEW CATCH BASINS SHALL BE INSTALLED WITH A TYPE A-4 CATCH BASIN INLET STONE. 15. NO ADDITIONAL PAYMENT WILL BE MADE FOR THE REMOVAL OF EXISTING PIPES.

ENGINEERING GROUP 189 MAIN STREET SUITE 200 YARMOUTH, ME 04096

CLIENT: SIMONS ARCHITECTS

75 YORK ST. PORTLAND, ME 04101

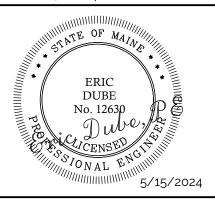

PHOSPHORUS MITIGATION TABLE					
	POINT TOTAL	PROPOSED POINT TOTAL			
CORRECTING EROSION AND SEDIMENTATION	10 POINTS	10 POINTS			
NEW BUILDING FOOTPRINT > 1,500 SF	10 POINTS	10 POINTS			
CLEARING LESS THAN 20% LOT AREAS	10 POINTS	10 POINTS			
ROCK LINED DRIP EDGE					
50% BUILDING	15 POINTS	-			
75% BUILDING	25 POINTS	25 POINTS			
TOTAL NUMBER OF POINTS REQUIRED	50 POINTS	55 POINTS			

TOWN OF RAYMOND ZONING SUMMARY ZONE R (RURAL) AND ZONE LRR1 (LIMITED RESIDENTIAL/RECREATIONAL DISTRICT 1)						
	EXISTING PROPOSED					
MIN. LOT AREA 3 ACRES 76± ACRES						
STREET FRONTAGE 225 FT 1,400'±						


MIN. FRONT SEBACK	40 FT	110'±
MIN. REAR SETBACK	20 FT	N/A
MIN. SIDE SETBACK	20 FT	40'±
MAX. BUILDING HEIGHT	2.5 STORIES	1 STORY

	LEGEND	
EXISTING	DESCRIPTION	PROPOSED
	GRANITE MONUMENT - 3' OFFSET	
O IPF	IRON PIN FOUND/SET	O IPS
O IRF	IRON ROD FOUND	
$\dot{ abla}$ Cirf	CAPPED IRON ROD FOUND	
• DHF	DRILL HOLE FOUND	
MON	GRANITE MONUMENT FOUND	
	STREET LINE	<u> </u>
	LOT SETBACKS	
	PROPERTY LINE	
	ABUTTER LINE	
	"NO CUT" BUFFER	
علاد علاد	WETLANDS	
	EDGE OF ROAD/TRAVELED WAY	
	SOIL TEST PIT	
420	CONTOUR	420
	SPOT GRADE	
© GAS	GAS SHUT-OFF	
UP Ø UP	UTILITY POLE	ပ်
OHU	OVERHEAD UTILTIES	ОНU
	UNDERGROUND ELECTRICAL	UGE
Т	ELECTRICAL TRANSFORMER	Т
ւ=	FIRE HYDRANT	-¢-
	WATER LINE	W
WG WG		
S (S) ^{SMH}	SEWER LINE SEWER MANHOLE	s
DMH	DRAINAGE MANHOLE	• DMH-1
СВ	CATCH BASIN	CB-1
SD	STORMDRAIN	■
UD	UNDERDRAIN	UD
	SILT FENCE	SF
	TREE LINE	U.





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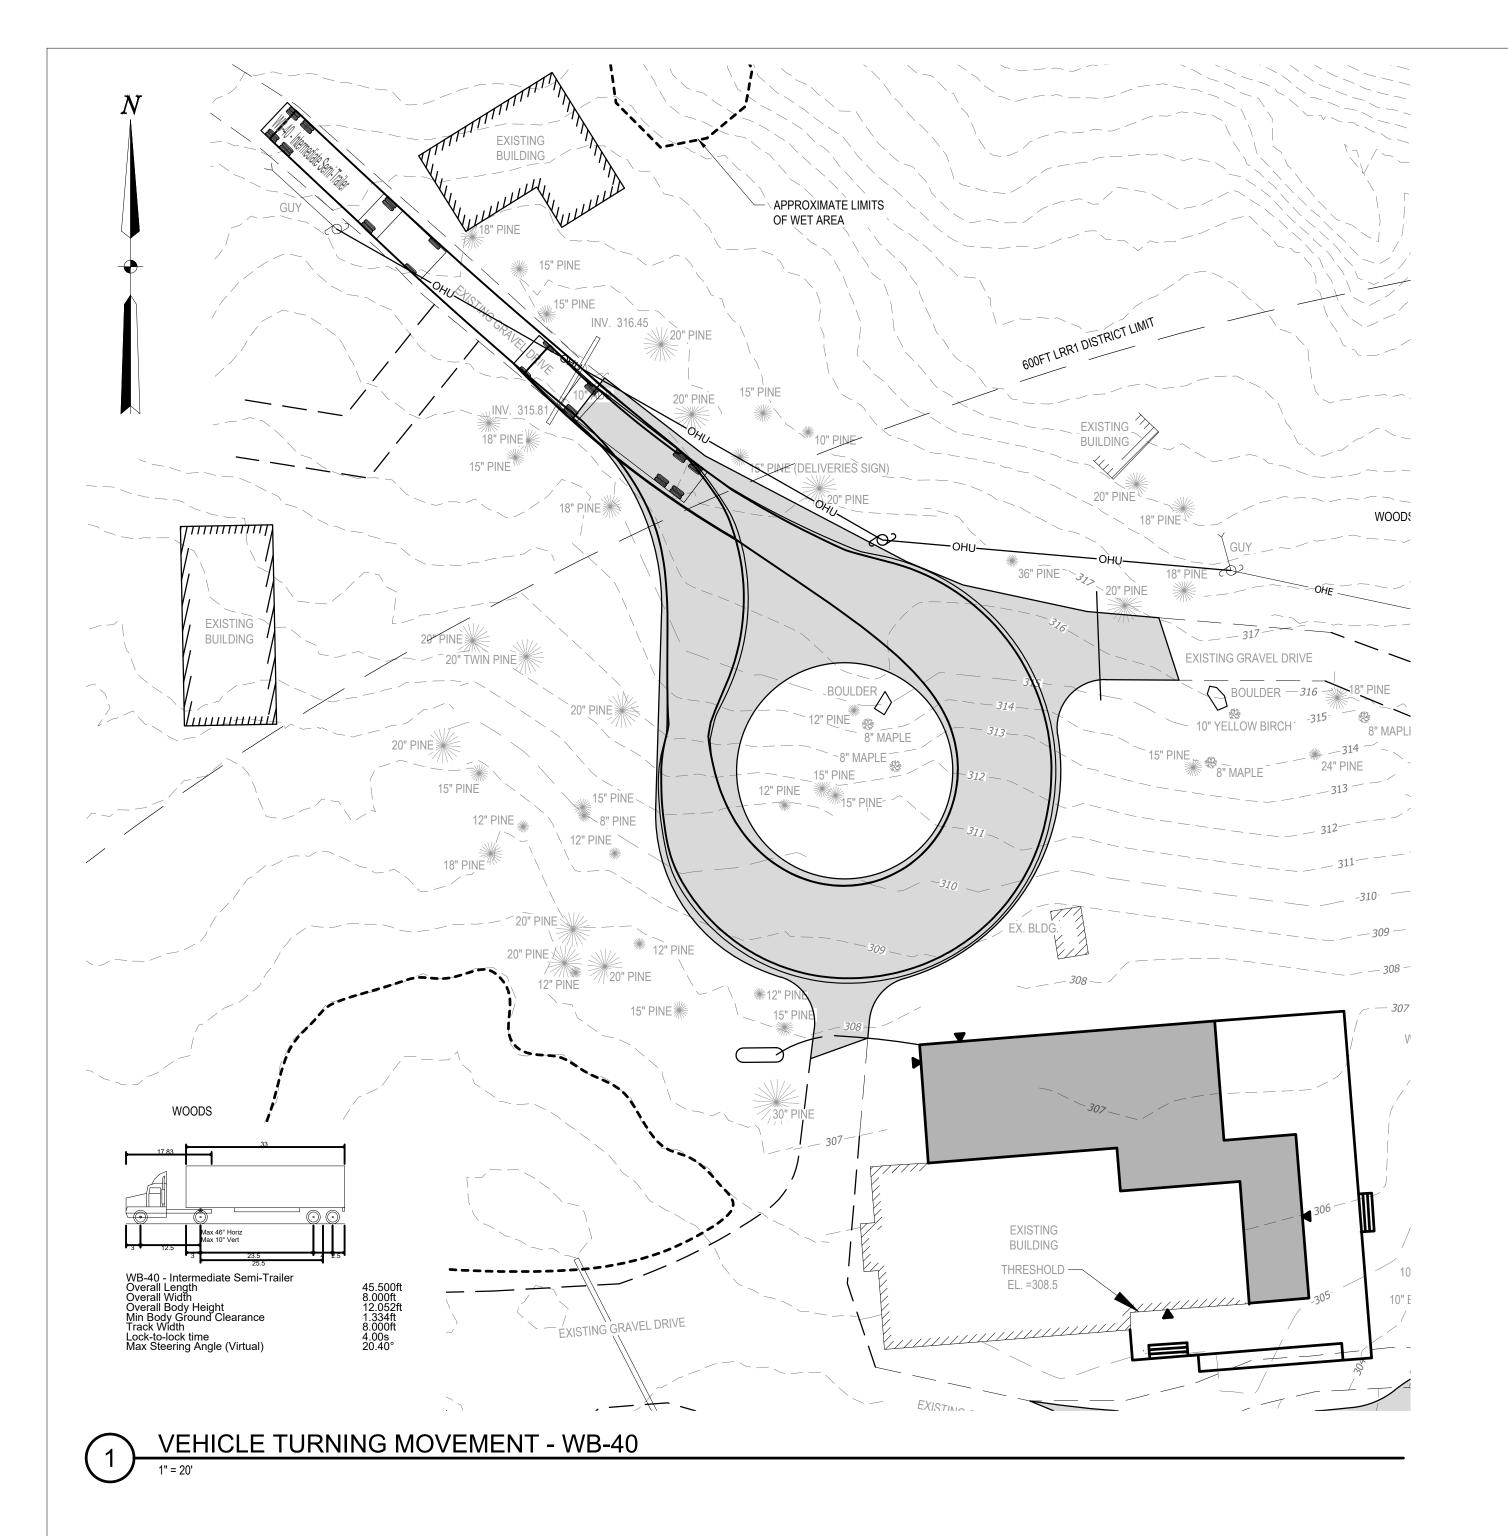


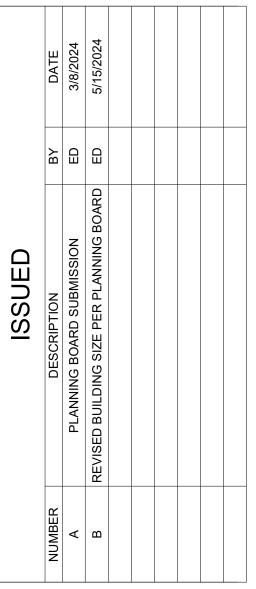
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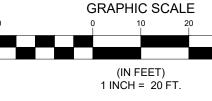
SITE AND GRADING PLAN


DESIGNED BY:	BVD
DRAWN BY:	BVD
PROJECT NUMBER:	22-224

C101






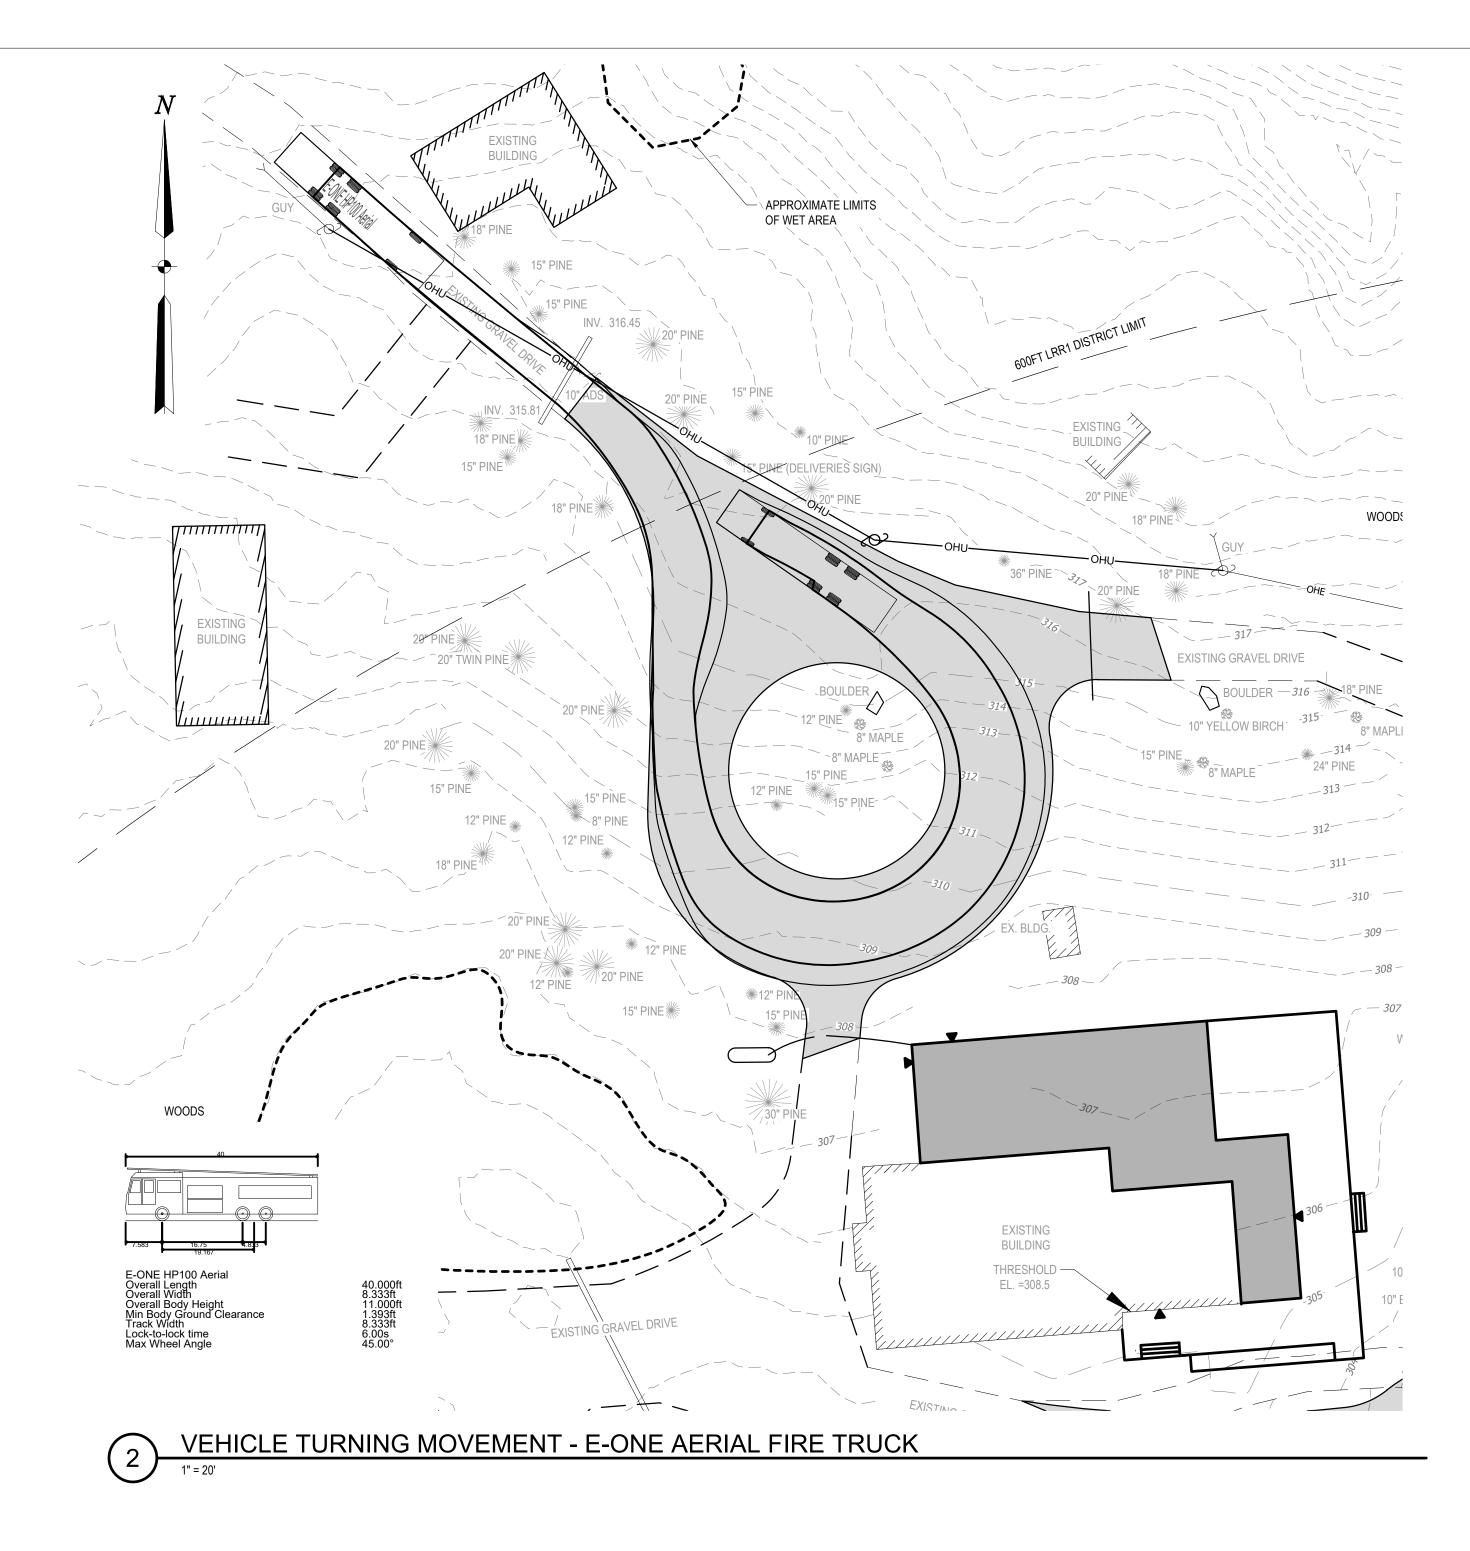


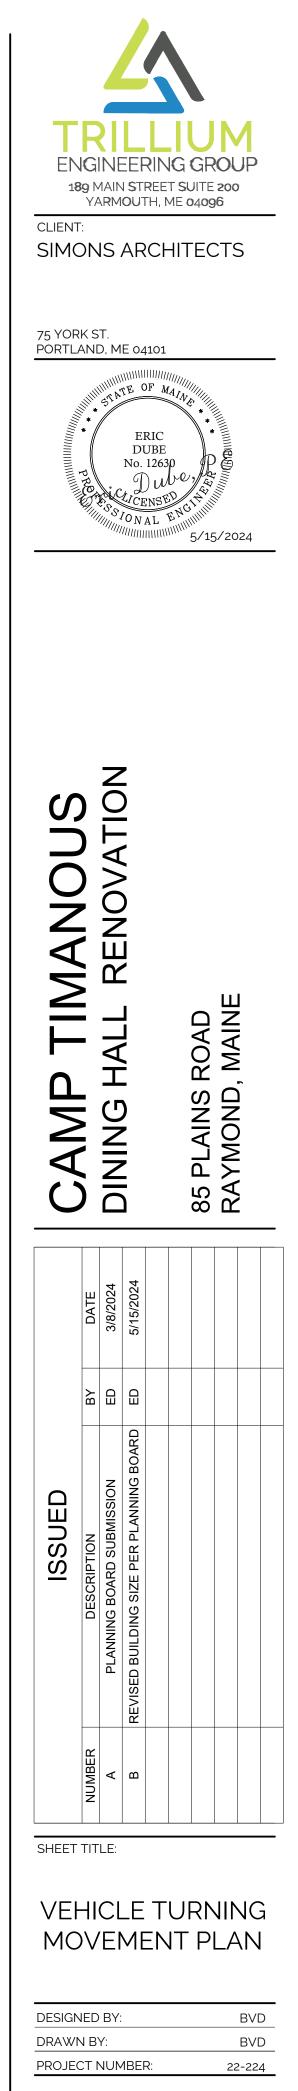




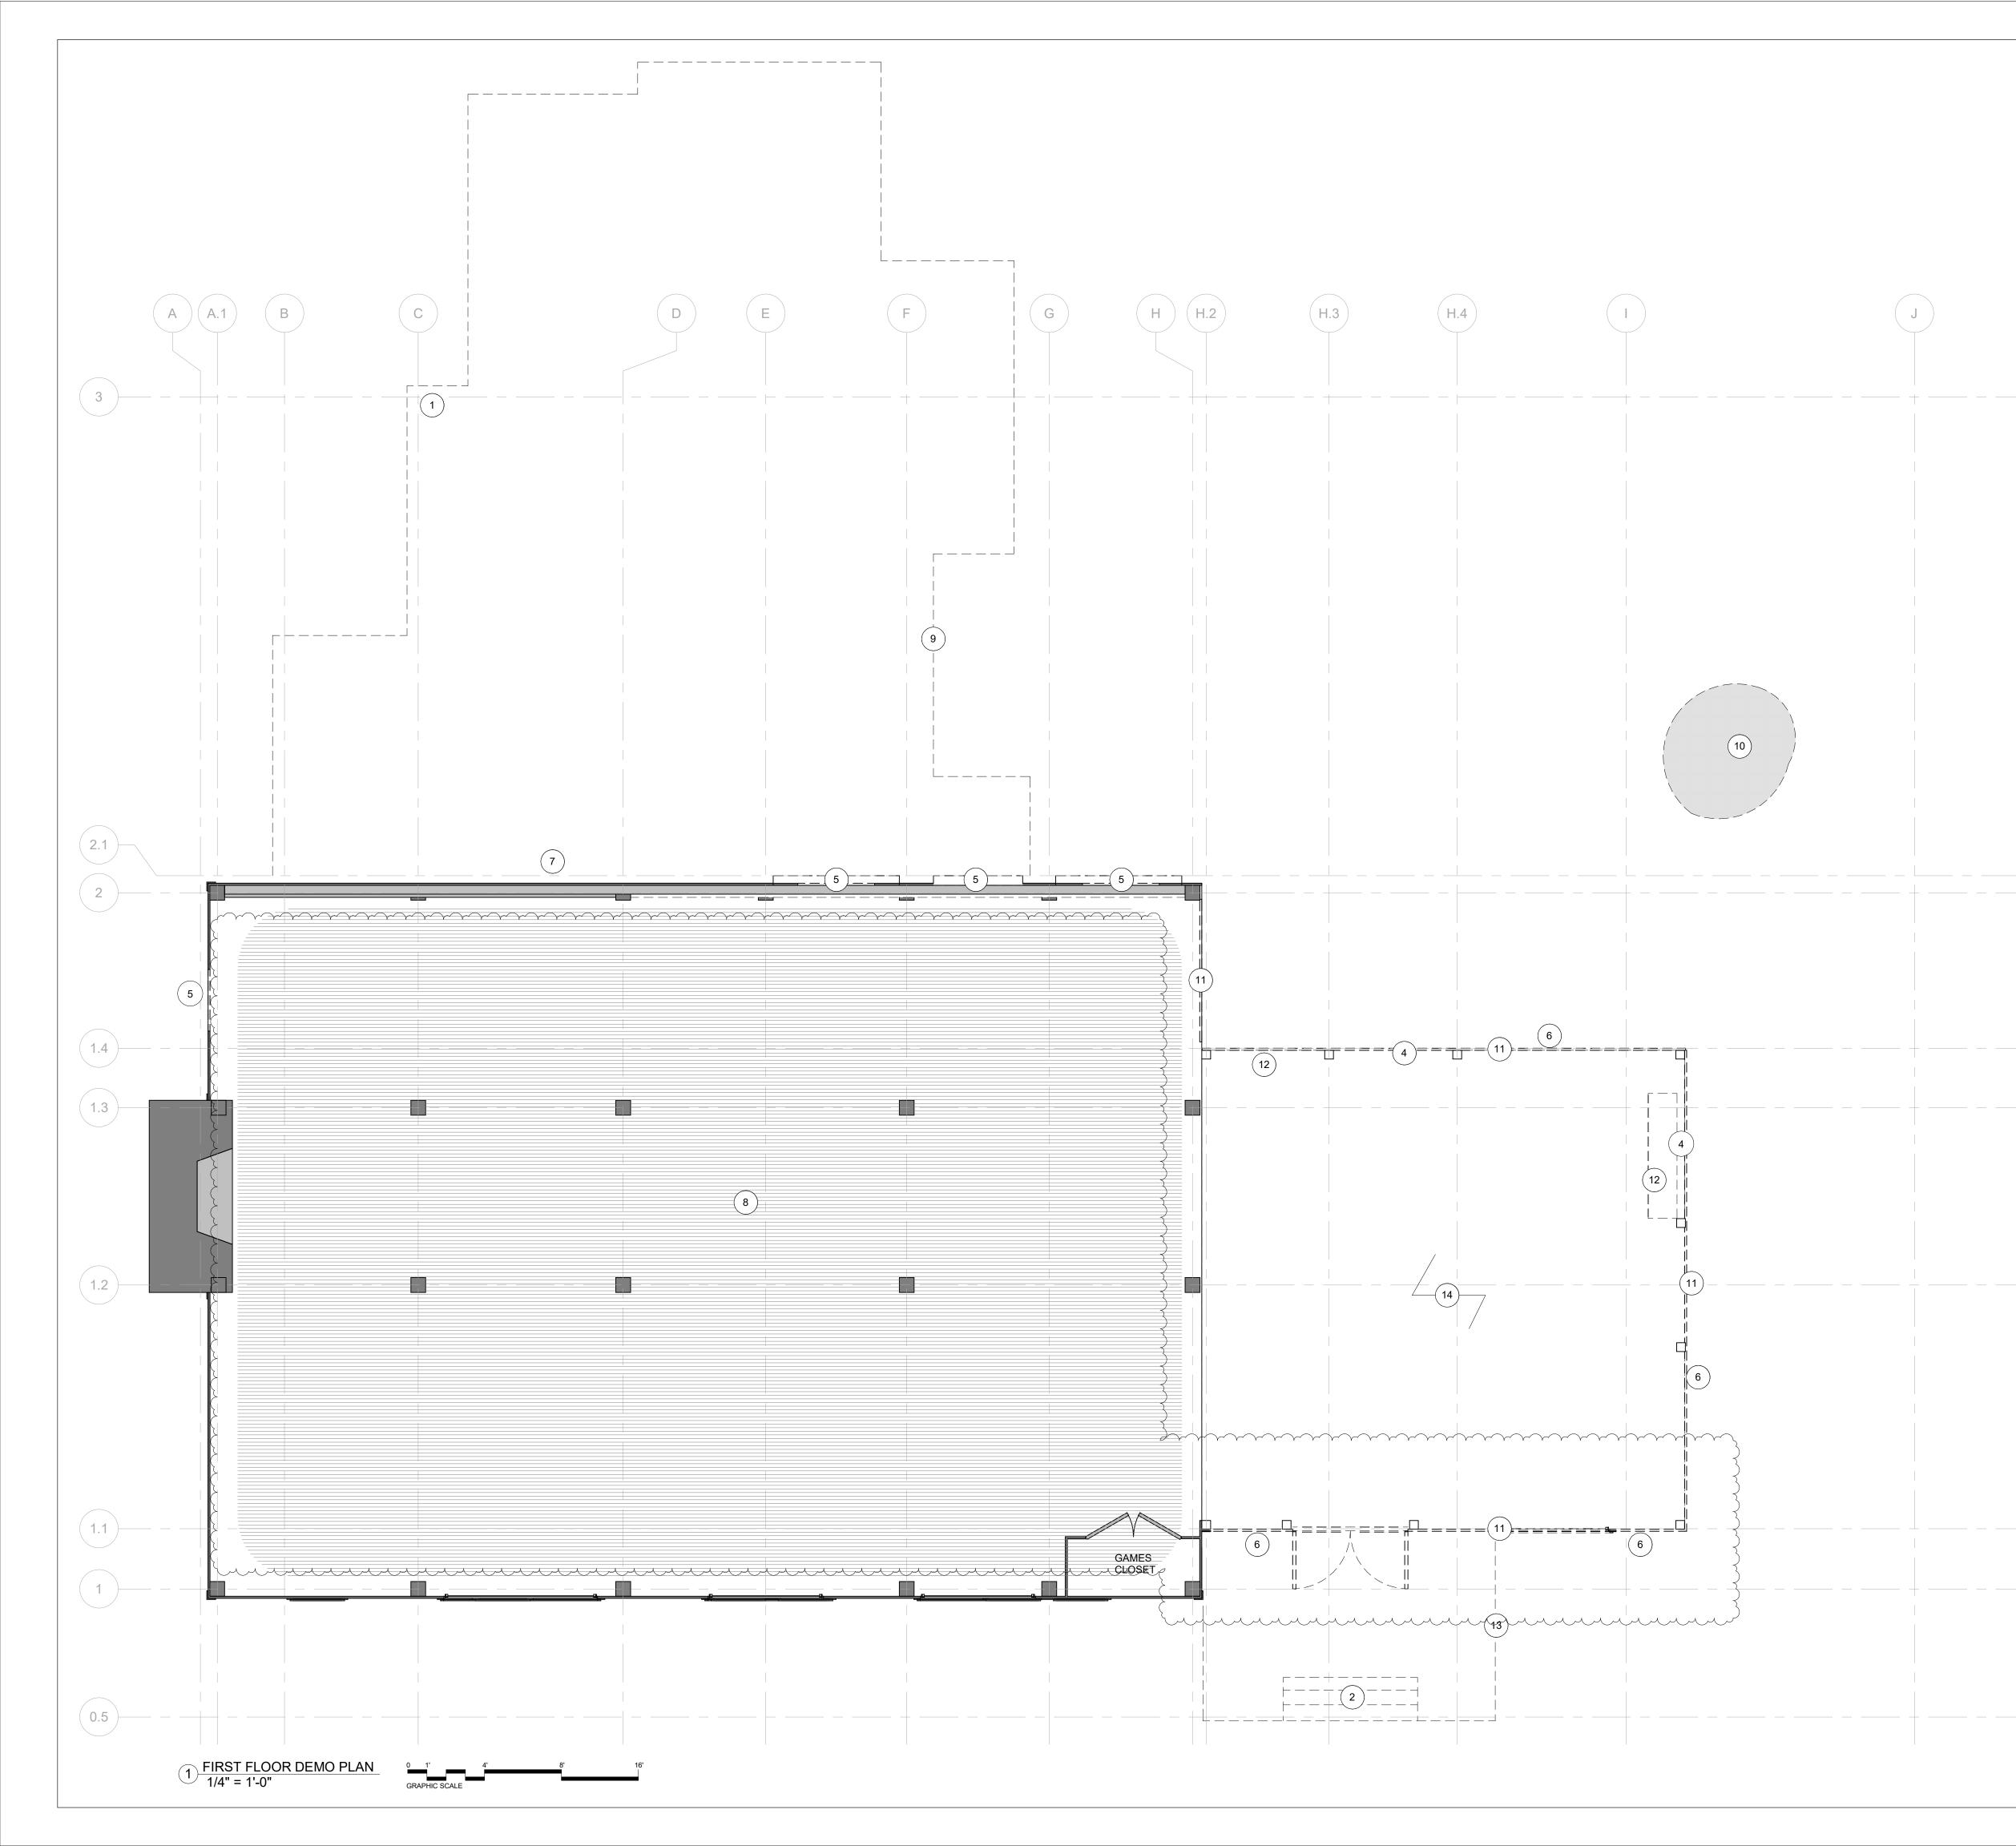



DEMO PLAN KEYNOTESNO.TEXT1APPROXIMATE LOCATION OF ELECTRICAL PANELS.2SALVAGE GRANITE TREADS FOR REUSE.3NOT USED4DEMO EXISTING WALL. PATCH AND REPAIR ADJACENT WALL AS NEEDED5CUT OPENING IN WALL FOR NEW DOOR OR WINDOW OPENING. PATCH AND REPAIR ADJACENT WALL AS NEEDED. NOTE: SEE STRUCTURAL RE: RELOCATION OF EXISTING TIMBER BEAM.6SIDING TO BE SALVAGED FOR REUSE7PREP EXTERIOR WALL FOR SHORING. COORDINATE WITH STRUCTURAL8WOOD FLOORING TO REMAIN, PROTECT DURING CONSTRUCTION UNTIL READY TO BE REFINISHED9EXISTING KITCHEN AND ACCOMPANYING STRUCTURES TO BE DEMOLISHED. *LINES SHOWN HERE ARE FOR ILLUSTRATION PURPOSES ONLY AND DO NOT REFLECT ACTUAL MEASUREMENTS10BOULDER TO BE REMOVED, SEE CIVIL11ENTIRE WALL TO BE DEMOLISHED 1213EXISTING DECK TO BE RELOCATED14ALL OF RESTAURANT SECTION TO BE DEMOLISHED14ALL OF RESTAURANT SECTION TO BE DEMOLISHED	<section-header><text></text></section-header>
 GENERAL NOTES A. SEE STRUCTURAL DOCUMENTS FOR ADDITIONAL DEMOLITION WORK AT EXISTING. B. GC SHALL BE RESPONSIBLE FOR ALL TEMPORARY SUPPORT, SHORING, AND BRACING AS REQUIRED. C. WORK TO BE SEQUENCED, SCHEDULED, AND OTHERWISE COORDINATED WITH OWNER. D. GC TO PROTECT ADJACENT AREAS NOT AFFECTED BY CONSTRUCTION. E. GC TO FIELD VERIFY CONDITIONS PRIOR TO BIDDING AND CONSTRUCTION. ALERT ARCHITECT IMMEDIATELY OF ANY AND ALL DISCREPANCIES. F. EXISTING MATERIALS NOTED FOR REMOVAL AND PROPER OFFSITE DISPOSAL PER APPLICABLE REGULATIONS. OWNER RESERVES THE RIGHT TO RETAIN ANY ITEM NOTED FOR DEMOLITION. G. GC SHALL COORDINATE EXTENT OF DEMOLITION PER REQUIREMENTS OF NEW CONSTRUCTION. MEP TO BE REMOVED SHALL EITHER BE REMOVED BACK TO SOURCE OR LOCATED OUT OF HARMS WAY FOR RELOCATION IN NEW CONSTRUCTION. GC SHALL BE RESPONSIBLE FOR CUTTING AND PATCHING AS REQUIRED FOR STRUCTURAL, MEP, AND FIRE PROTECTION WORK. COORDINATE AS REQUIRED TO MATCH EXISTING. AREAS OF BUILDING NOTE PART OF THIS SCOPE OF WORK ARE SHOWN HATCHED FOR GENERAL REFERENCE ONLY. SOME MEP WORK WILL REQUIRE INTERVENTION BEATOF THIS SCOPE OF WORK ARE SHOWN HATCHED FOR GENERAL REFERENCE ONLY. SOME MEP WORK WILL REQUIRE INTERVENTION BEATOF AREAS OF BUILDING NOTE PART OF THIS SCOPE OF WORK ARE SHOWN HATCHED FOR GENERAL REFERENCE ONLY. SOME MEP WORK WILL REQUIRE INTERVENTION BEATOF MEPAIRED TO MATCH EXISTING. AREAS OF BUILDING NOTE PART OF THIS SCOPE OF WORK ARE SHOWN HATCHED FOR GENERAL REFERENCE ONLY. SOME MEP WORK WILL REQUIRE INTERVENTION BEATOF MED TO MATCH EXISTING. AREAS OF BUILDING NOTE PART OF THIS SCOPE OF WORK ARE SHOWN HATCHED FOR GENERAL REFERENCE ONLY. SOME MEP WORK WILL REQUIRE INTERVENTION BEATOF MED TO MATCH AXISTING, AND FOUNDATIONS AS INDICATED ON STRUCTURAL DOCUMENTS. 	PROJECT NAME: CAMP TIMANOUS SEAL: SEAL: THIS DRAWING IS THE PROPERTY OF SIMONS ARCHITECTS (SA) AND IS NOT OB COPIED OR REPRODUCED IN PART OR WHOLE. 2024 O SIMONS ARCHITECTS, LLC I SOURCES 1 SOW DESIGN 1 SOW DESIGN 2 BULLETIN 1
K. ALL UTILITIES TO BE FIELD VERIFIED WITH TOWN OF RAYMOND PRIOR TO ANY DIGGING. EXPECT THAT HAND DIGGING WILL BE REQUIRED TO DETERMINE ACTUAL DEPTH OF UTILITIES.	DATE OF ISSUE: 05/10/2024 PROJECT NUMBER: 2023-0050 STATUS: BULLETIN 1 DENDLITION DENDLITION DLATE OF ISSUE: 05/10/2024 BULLETIN 1

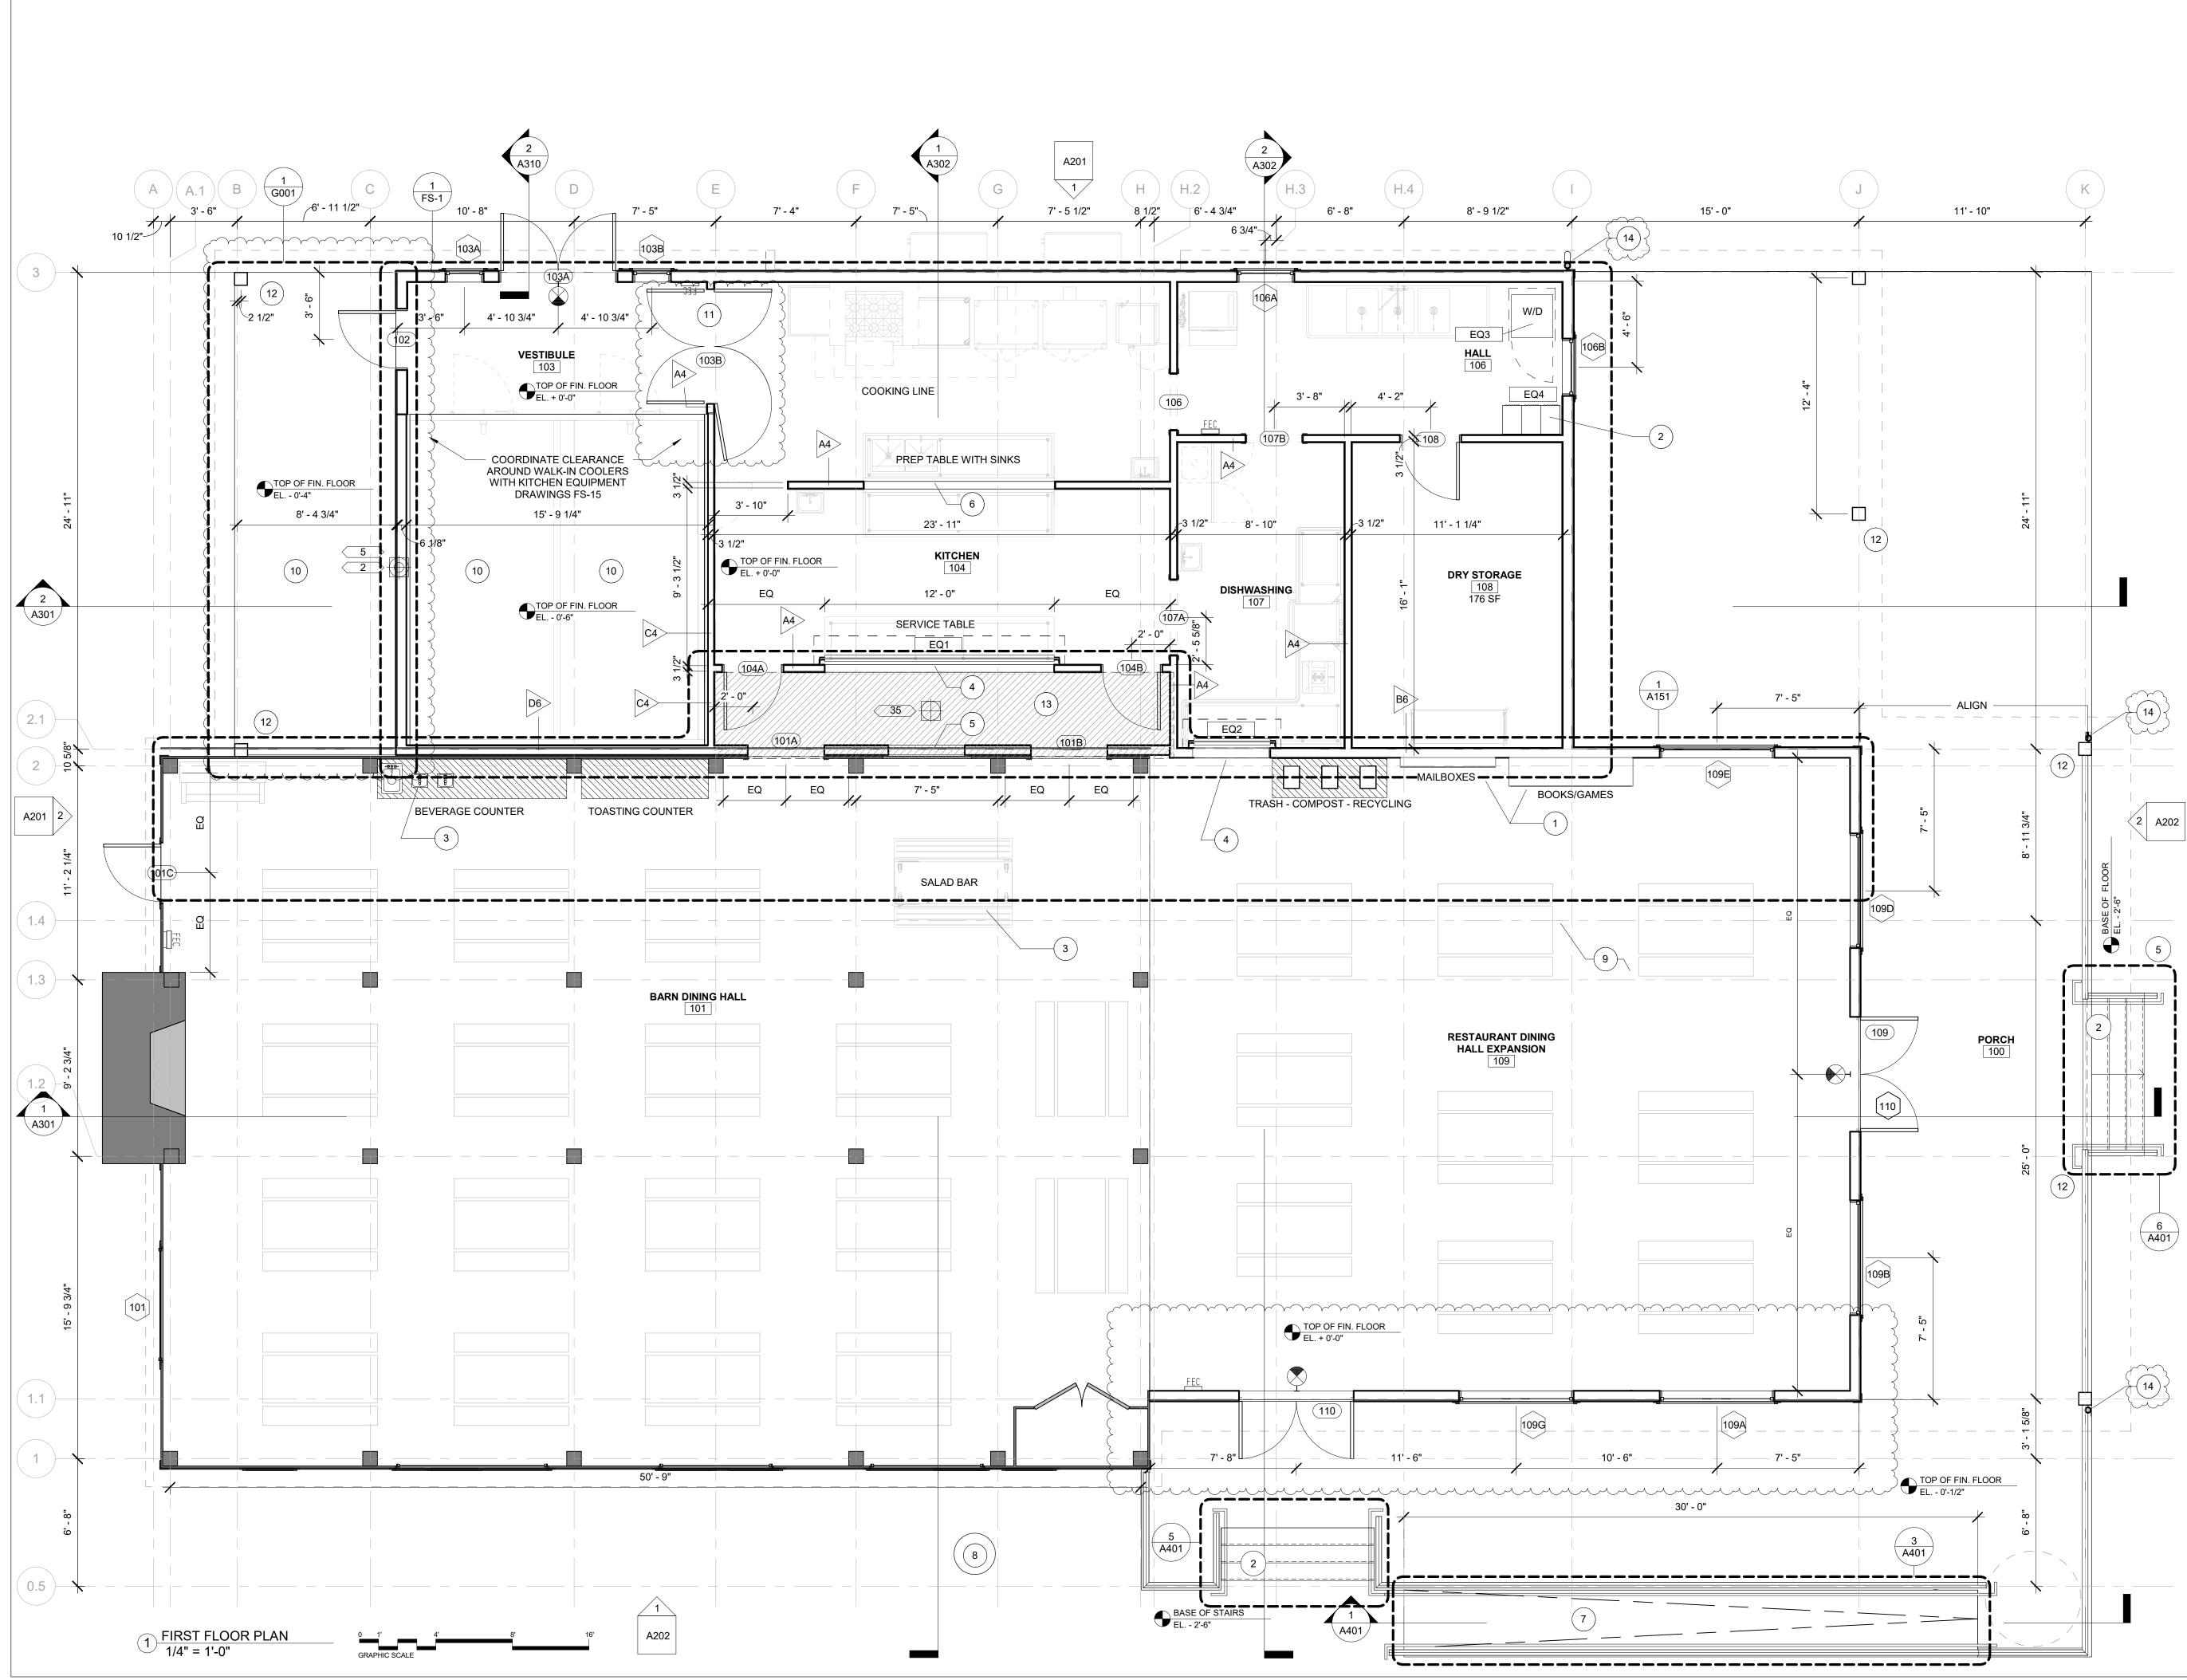


PLAN KEYNOTES TEXT NO. OWNER SUPPLIED WOOD SHELVING. GC TO MOUNT ON NEW WALL, RE: BLOCKING LOCKERS BY OWNER, GC TO INSTALL. REFERENCE KITCHEN DRAWINGS FOR SPECIFIC DRAIN AND ELECTRICAL LOCATION OVERHEAD WOOD ROLLING SHUTTER CASED 48" WIDE WINDOW OPENING. MATCH SILL AND HEAD HEIGHTS WITH SERVING COUNTER 75 York Street FINISHED OPENING, COORDINATE Portland, Maine 04101 WITH KITCHEN EQUIPMENT simonsarchitects.com DRAWINGS 207.772.4656 H.C. RAMP SLOPE @ 1"/12' - 0" LOCATION OF TREE TO BE VERIFIED OUTLINE OF EXISITNG BUILDING BELOW. ALL FLOOR IS NEW DEPRESSED SLAB, COORD WITH STRUCTURAL DRAWINGS DOUBLE ACTING DOOR. SEE SCHEDULE FOR MORE INFORMATION 12 8X8 COLUMNS, TYP DEPRESS SLAB AS NEEDED SO THAT FINISH FLOOR IS LEVEL WITH ETR IN DINING HALL AND NEW IN KITCHEN. COORDINATE WITH SCHEDULED FINISH. 14 DOWNSPOUT , www. GENERAL NOTES SEE STRUCTURAL DOCUMENTS FOR FULL STRUCTURAL SCOPE OF WORK GC SHALL BE RESPONSIBLE FOR ALL TEMPORARY SUPPORT, SHORING, AND BRACING AS REQUIRED. WORK TO BE SEQUENCED, SCHEDULED, AND OTHERWISE COORDINATED WITH OWNER. GC TO PROTECT ADJACENT AREAS NOT AFFECTED BY CONSTRUCTION. GC TO FIELD VERIFY CONDITIONS PRIOR TO BIDDING AND CONSTRUCTION. ALERT ARCHITECT IMMEDIATELY OF ANY AND ALL DISCREPANCIES. AREAS OF BUILDING NOTE PART OF THIS SCOPE OF WORK ARE SHOWN HATCHED FOR GENERAL REFERENCE ONLY. SOME MEP WORK WILL REQUIRE INTERVENTION BEYOND LIMIT OF WORK AREAS. ALL UTILITIES TO BE FIELD VERIFIED WITH TOWN OF RAYMOND PRIOR TO PROJECT NAME: ANY DIGGING. EXPECT THAT HAND DIGGING WILL BE REQUIRED TO DETERMINE ACTUAL DEPTH OF UTILITIES. **EXISTING VS NEW LEGEND** 85 PLAINS RD, RAYMOND, ME 04071 EXISTING SEAL: NEW _____ PART OR WHOLE. 1 50% DESIGN DEVELOPMENT 2 BULLETIN 1 DATE OF ISSUE: PROJECT NUMBER: STATUS: **REFERENCE COVER FOR** SYMBOL LEGEND PLAN

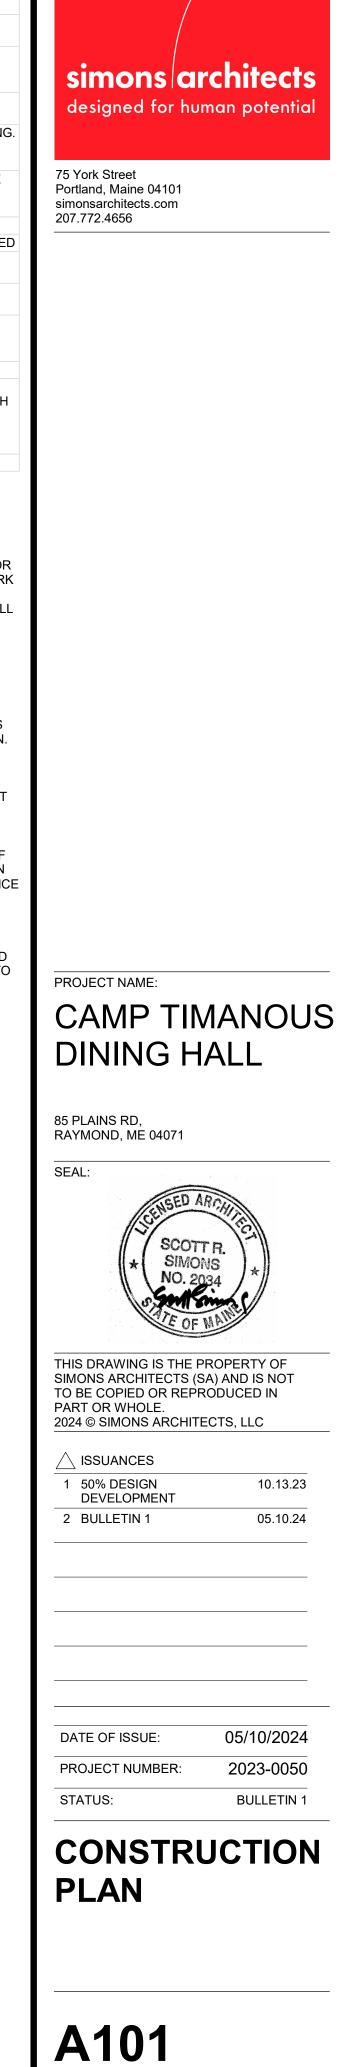


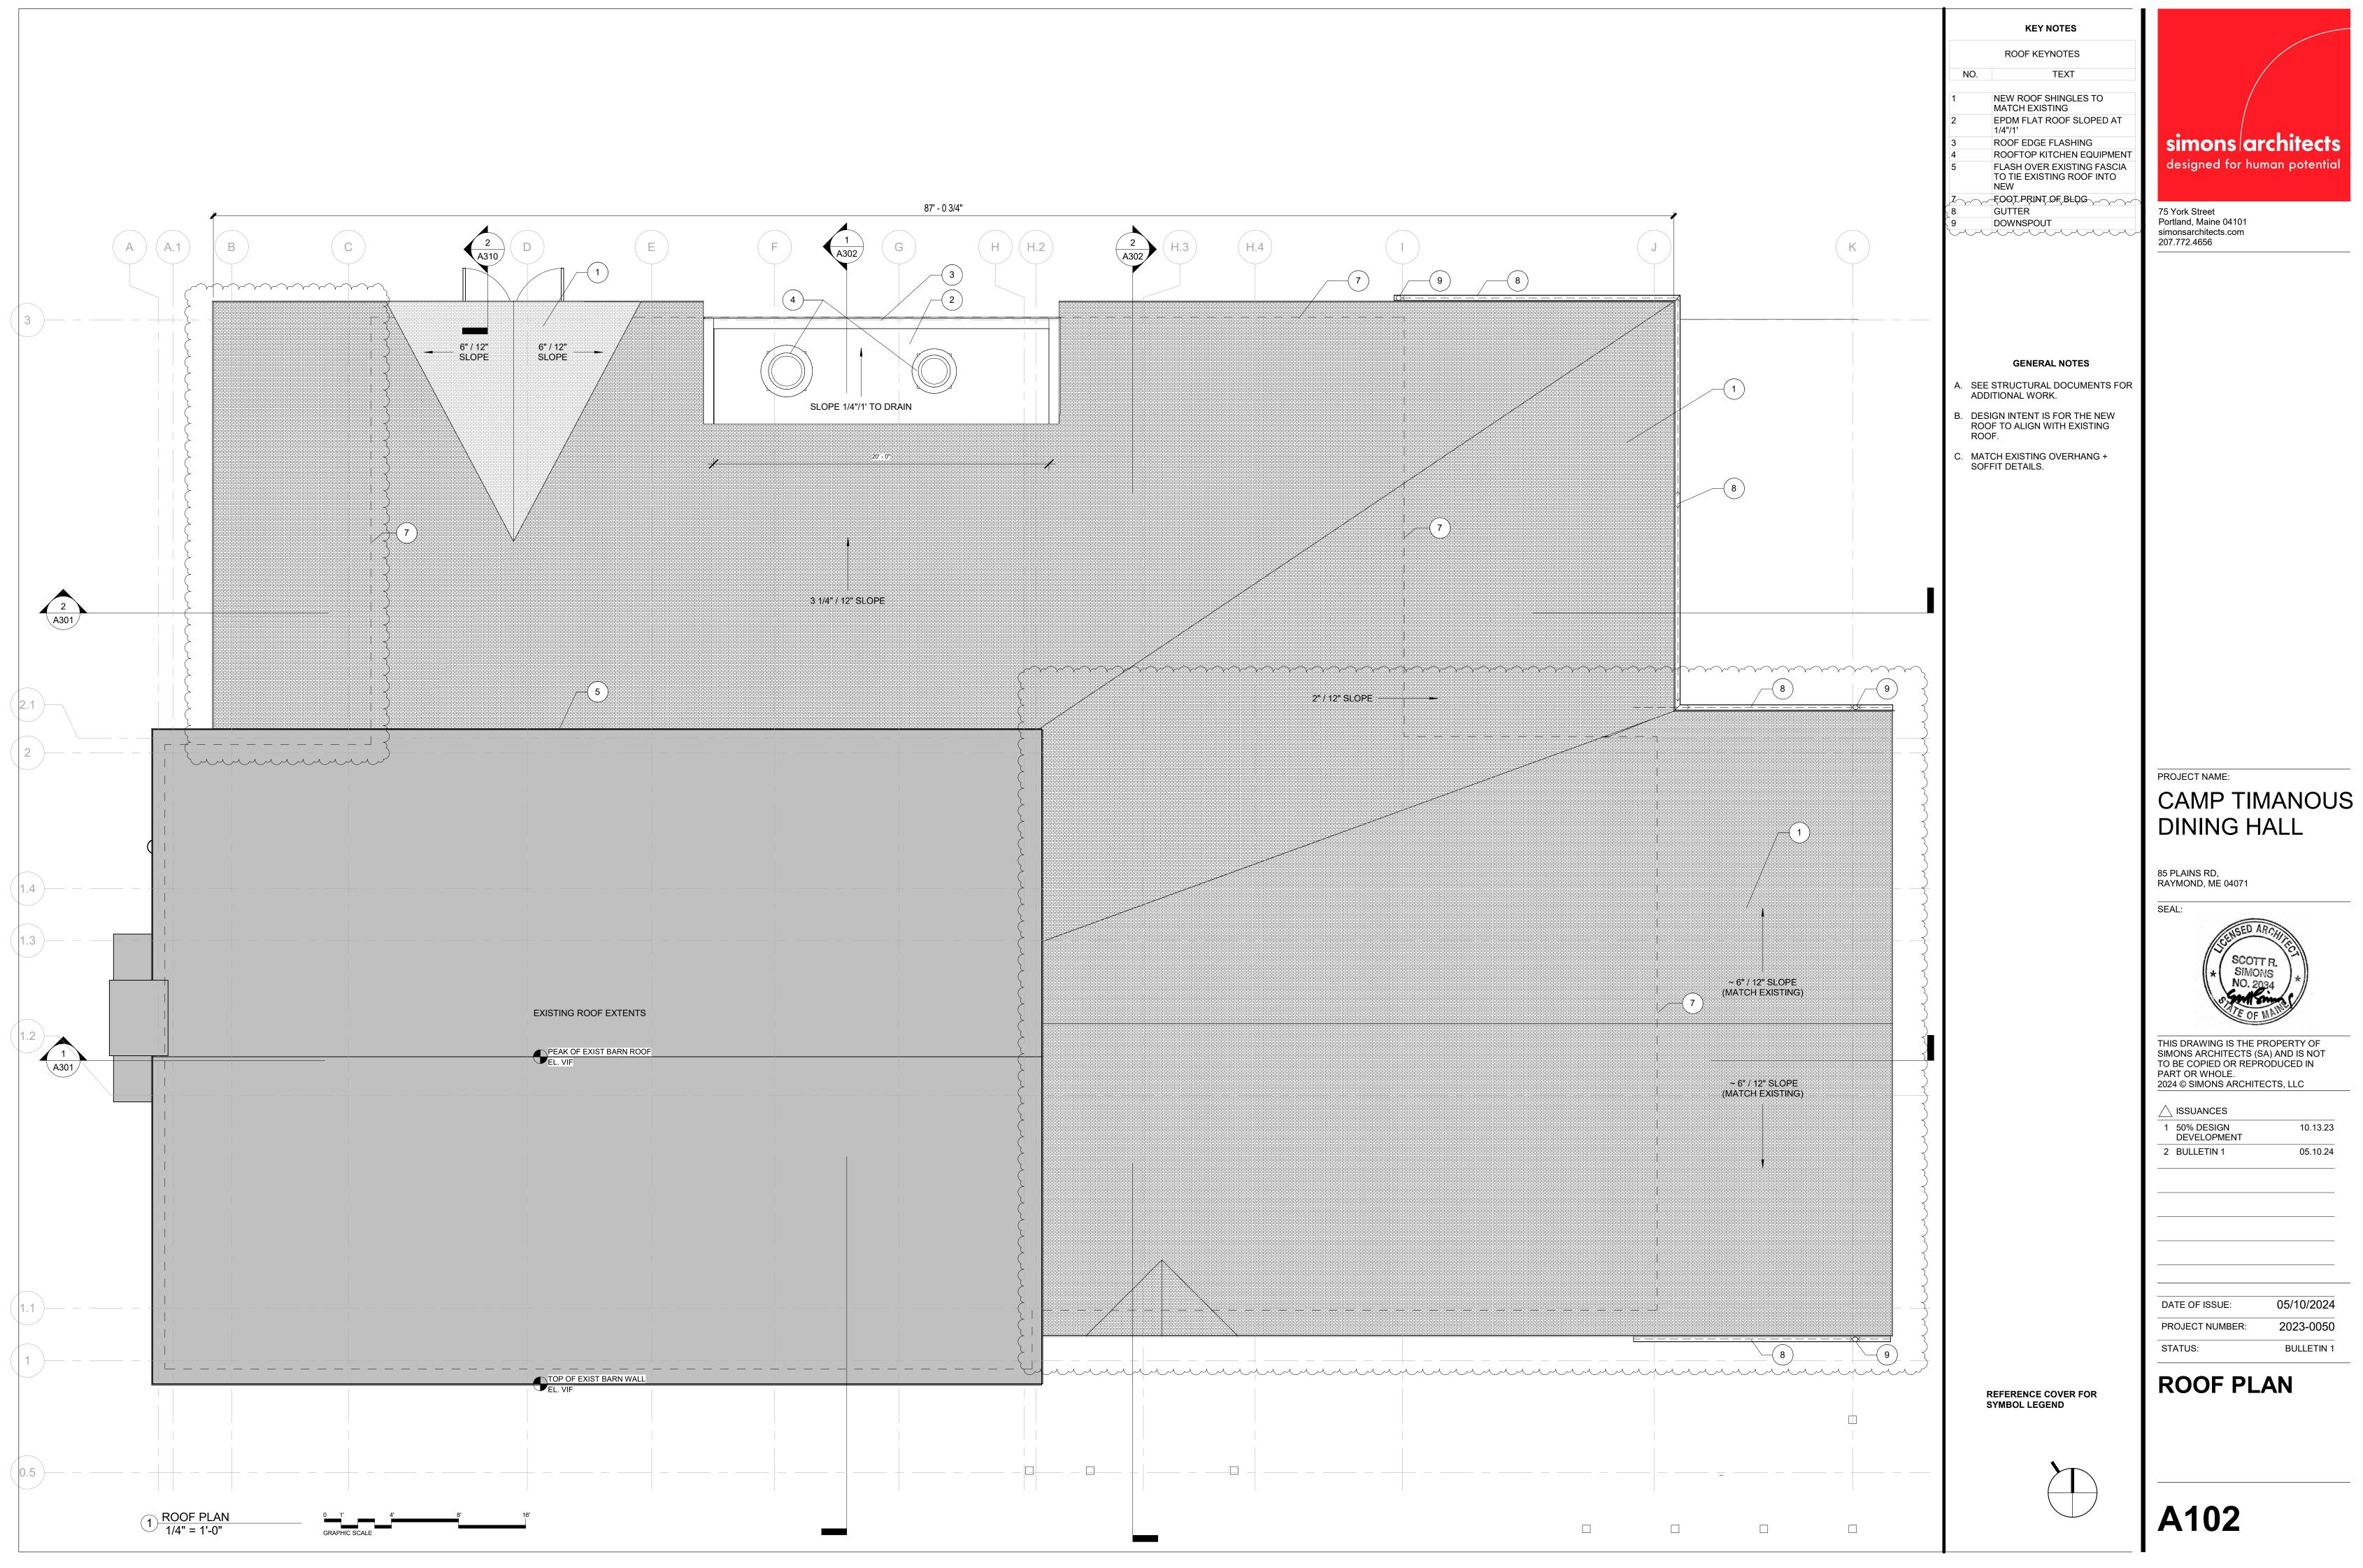

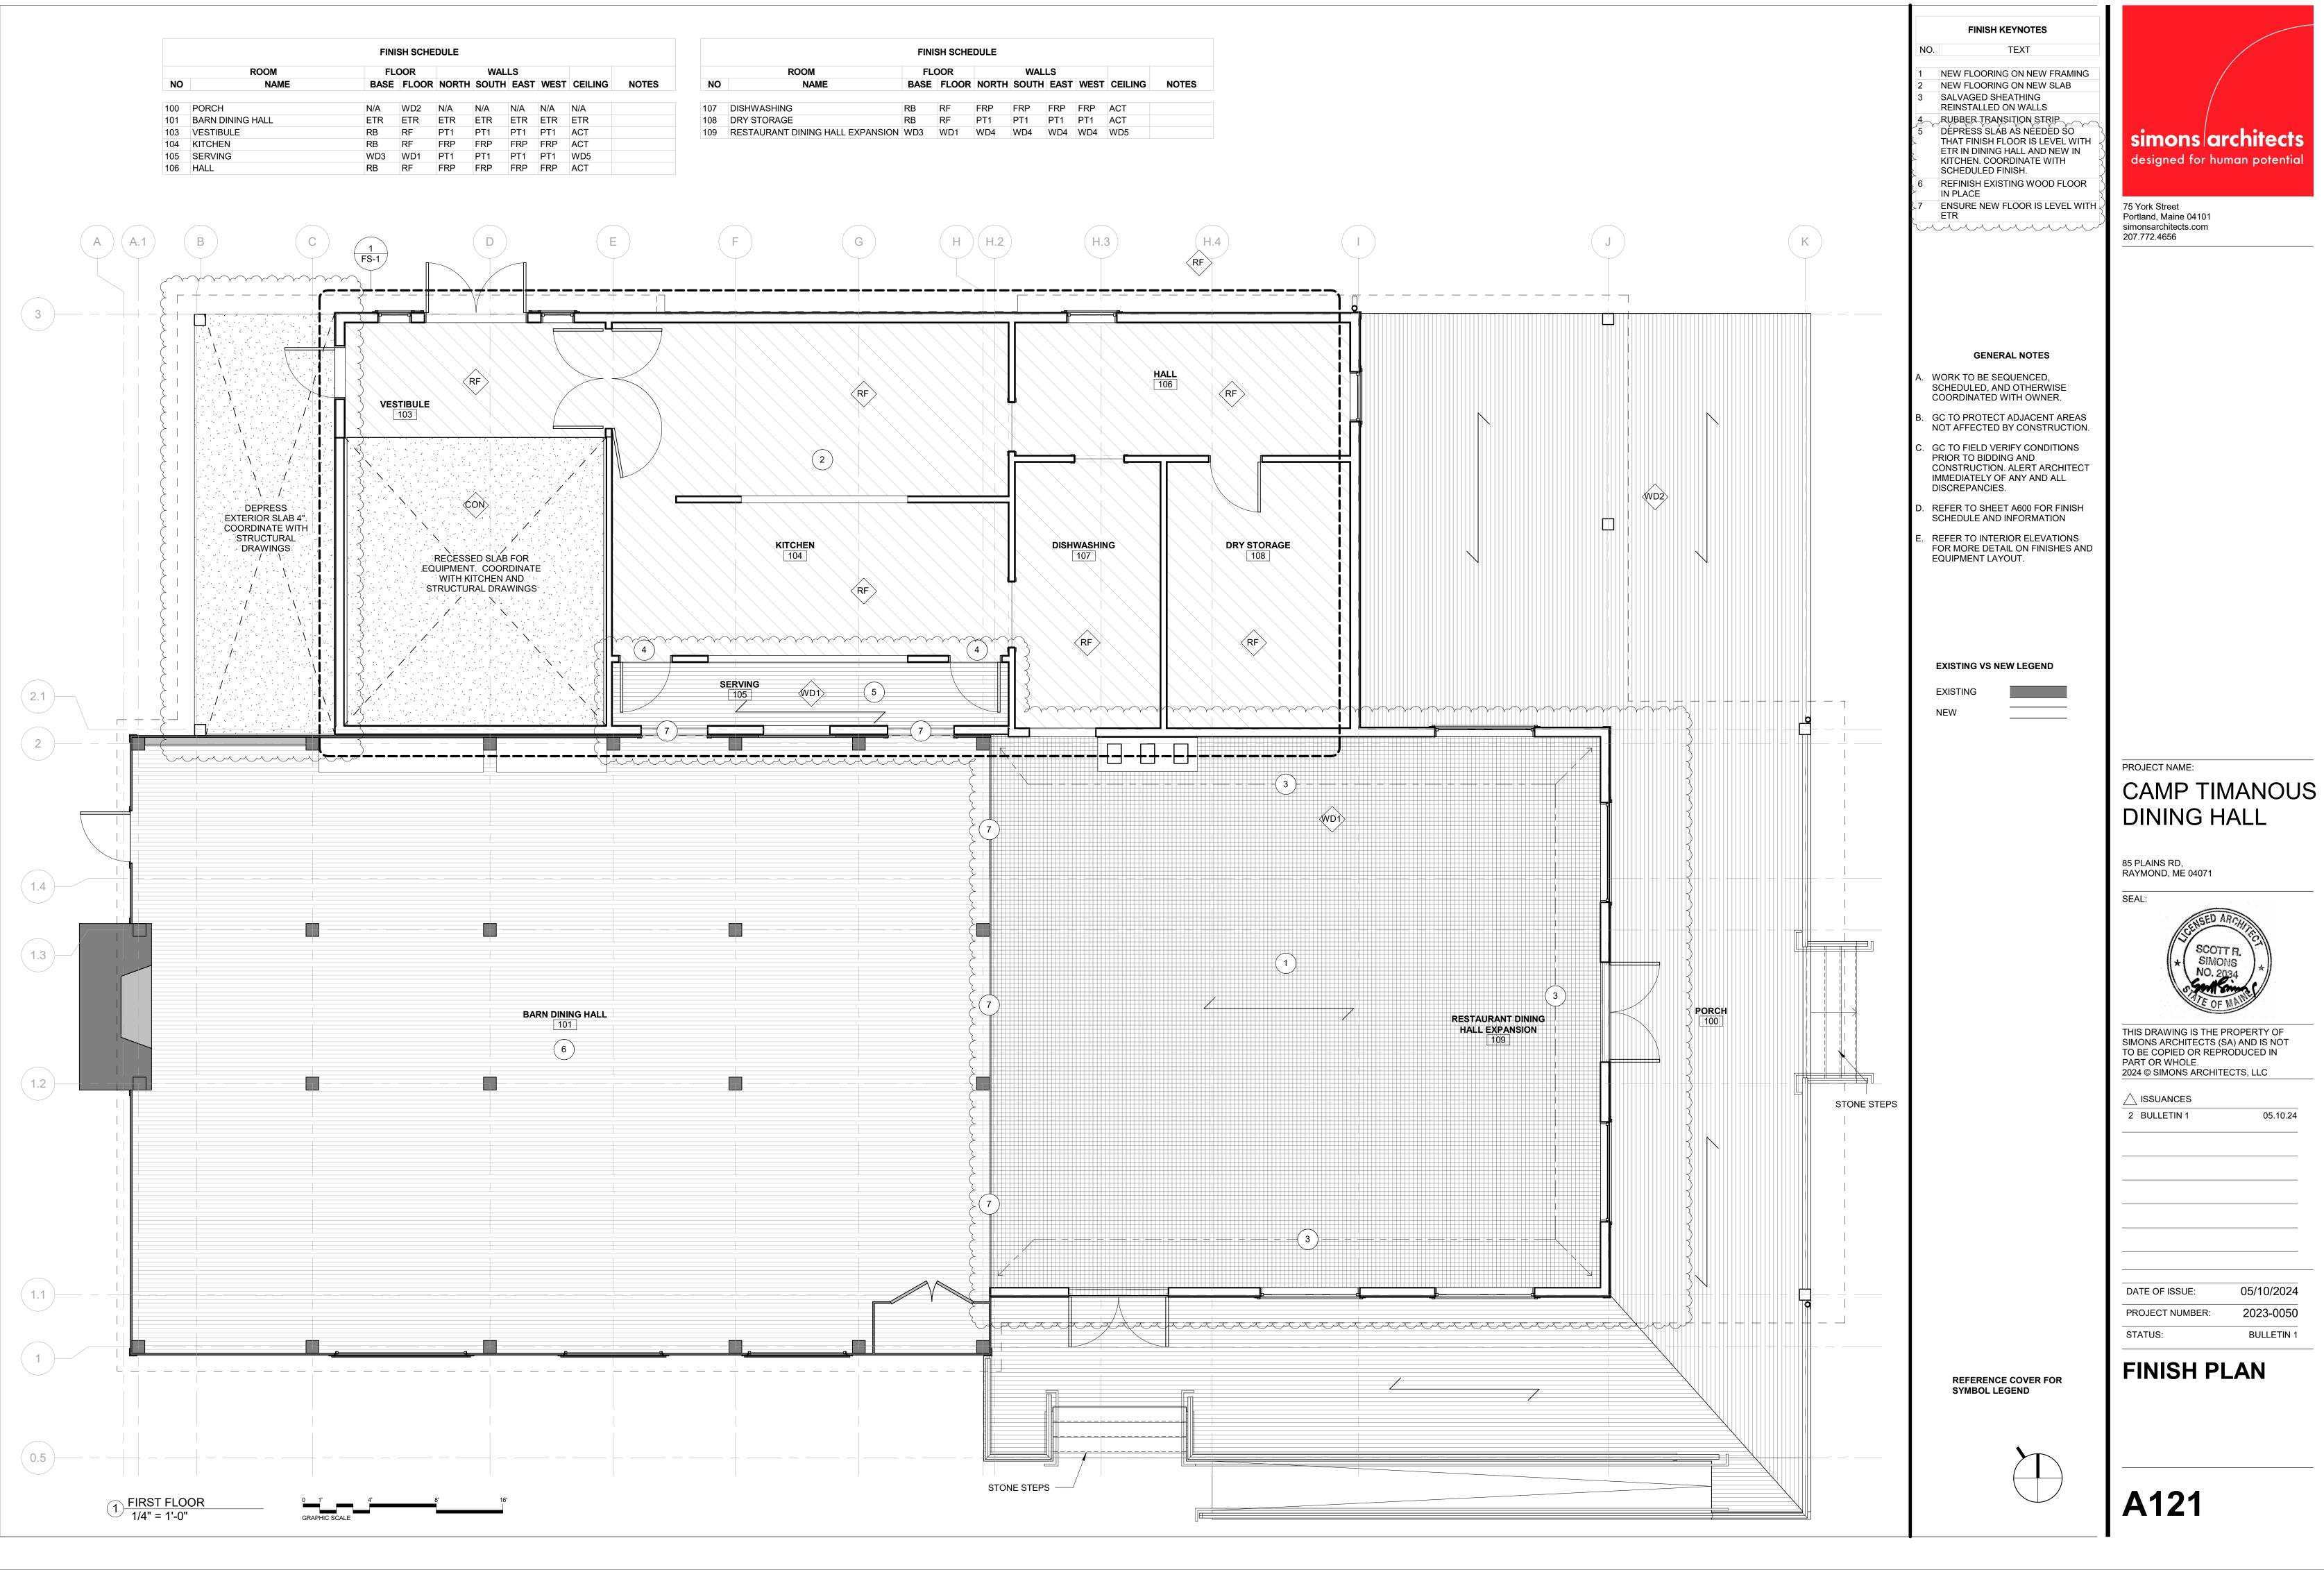

	FINI	SH SCHE	DULE					
ROOM	FLOOR		WALLS					
NAME	BASE	FLOOR	NORTH	SOUTH	EAST	WEST	CEILING	NOTES
ING	RB	RF	FRP	FRP	FRP	FRP	ACT	
AGE	RB	RF	PT1	PT1	PT1	PT1	ACT	
NT DINING HALL EXPANSION	WD3	WD1	WD4	WD4	WD4	WD4	WD5	

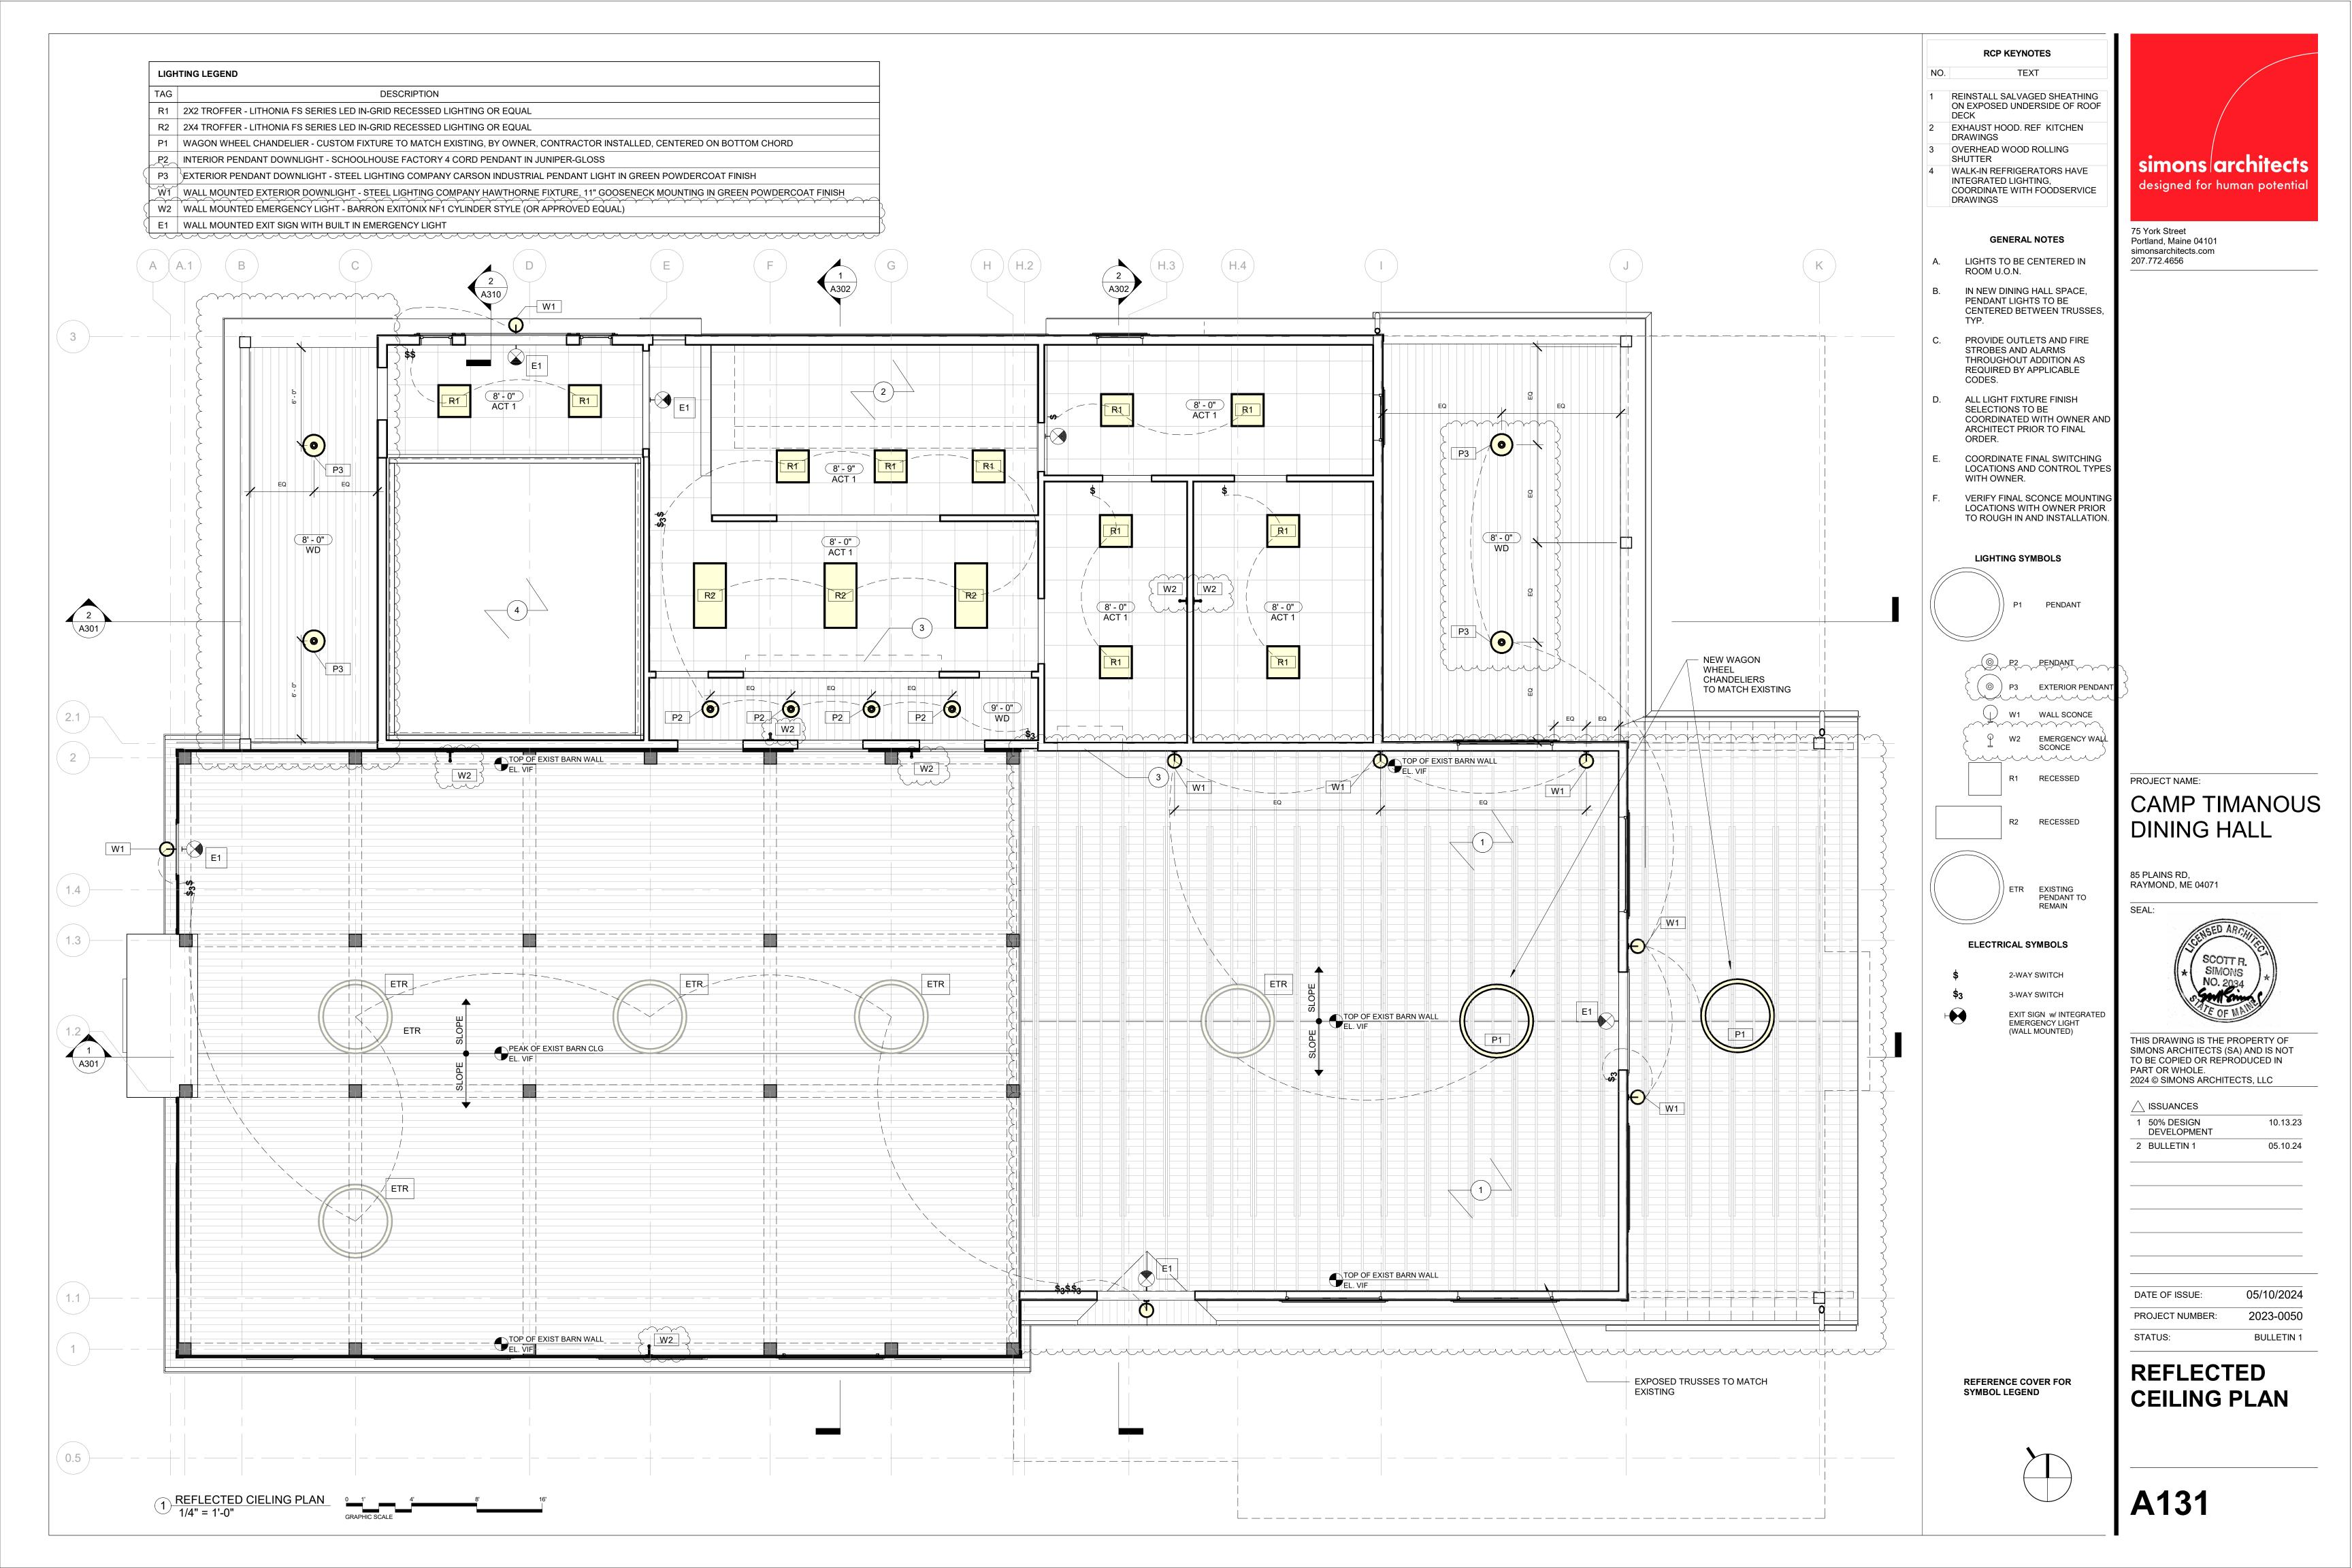

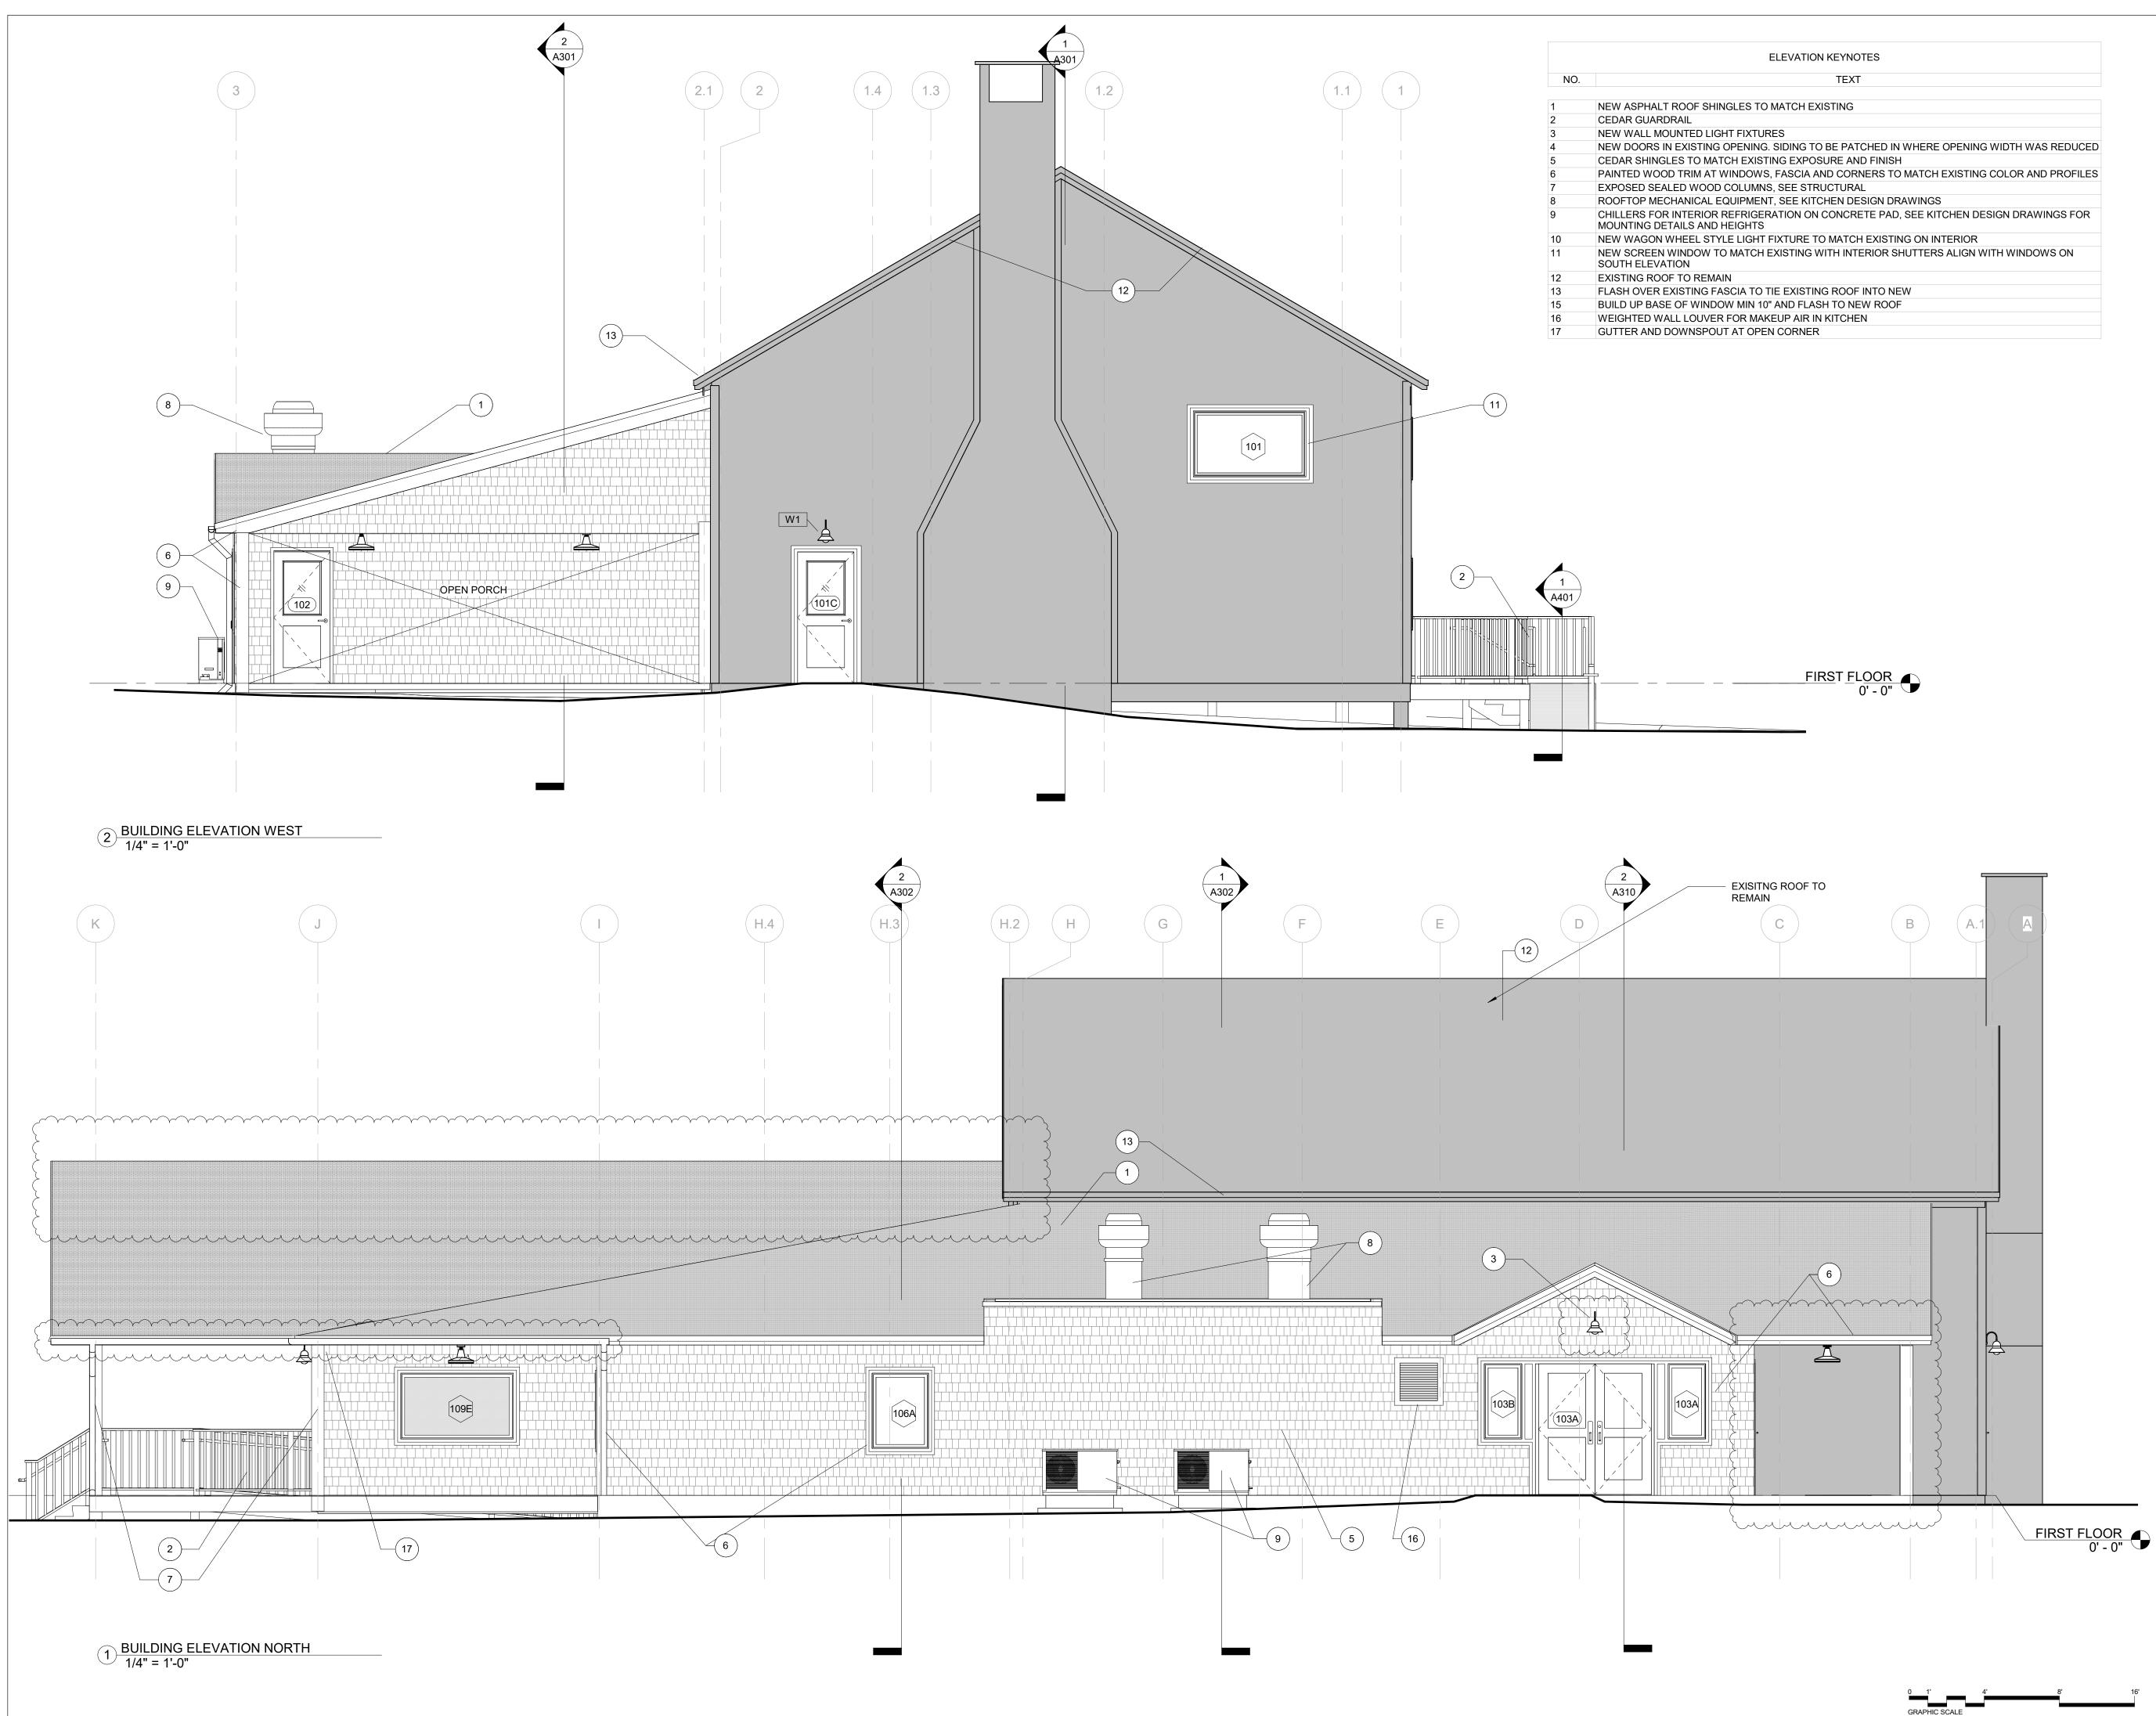

(EYNOTES	
TEXT	

SYMBOL LEGEND						
ROOM NUMBER	ROOM NAME					
DOOR NUMBER	(101A)					
WINDOW NUMBER	101A					
PARTITION TYPE	A3>					
PLUMBING FIXTURE	PF-					
EQUIPMENT/ ACCESSORY TAG	AC-					
FLOOR FINISH	WD					
WALL/BASE FINISH	XY AB					
FINISH TAG	WD					
KEYNOTE	1					

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75 York Street Portland, Maine 04101 simonsarchitects.com 207.772.4656

PROJECT NAME: CAMP TIMANOUS **DINING HALL**

85 PLAINS RD, RAYMOND, ME 04071

SEAL:



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1 50% DESIGN DEVELOPMENT 10.13.23 05.10.24 2 BULLETIN 1


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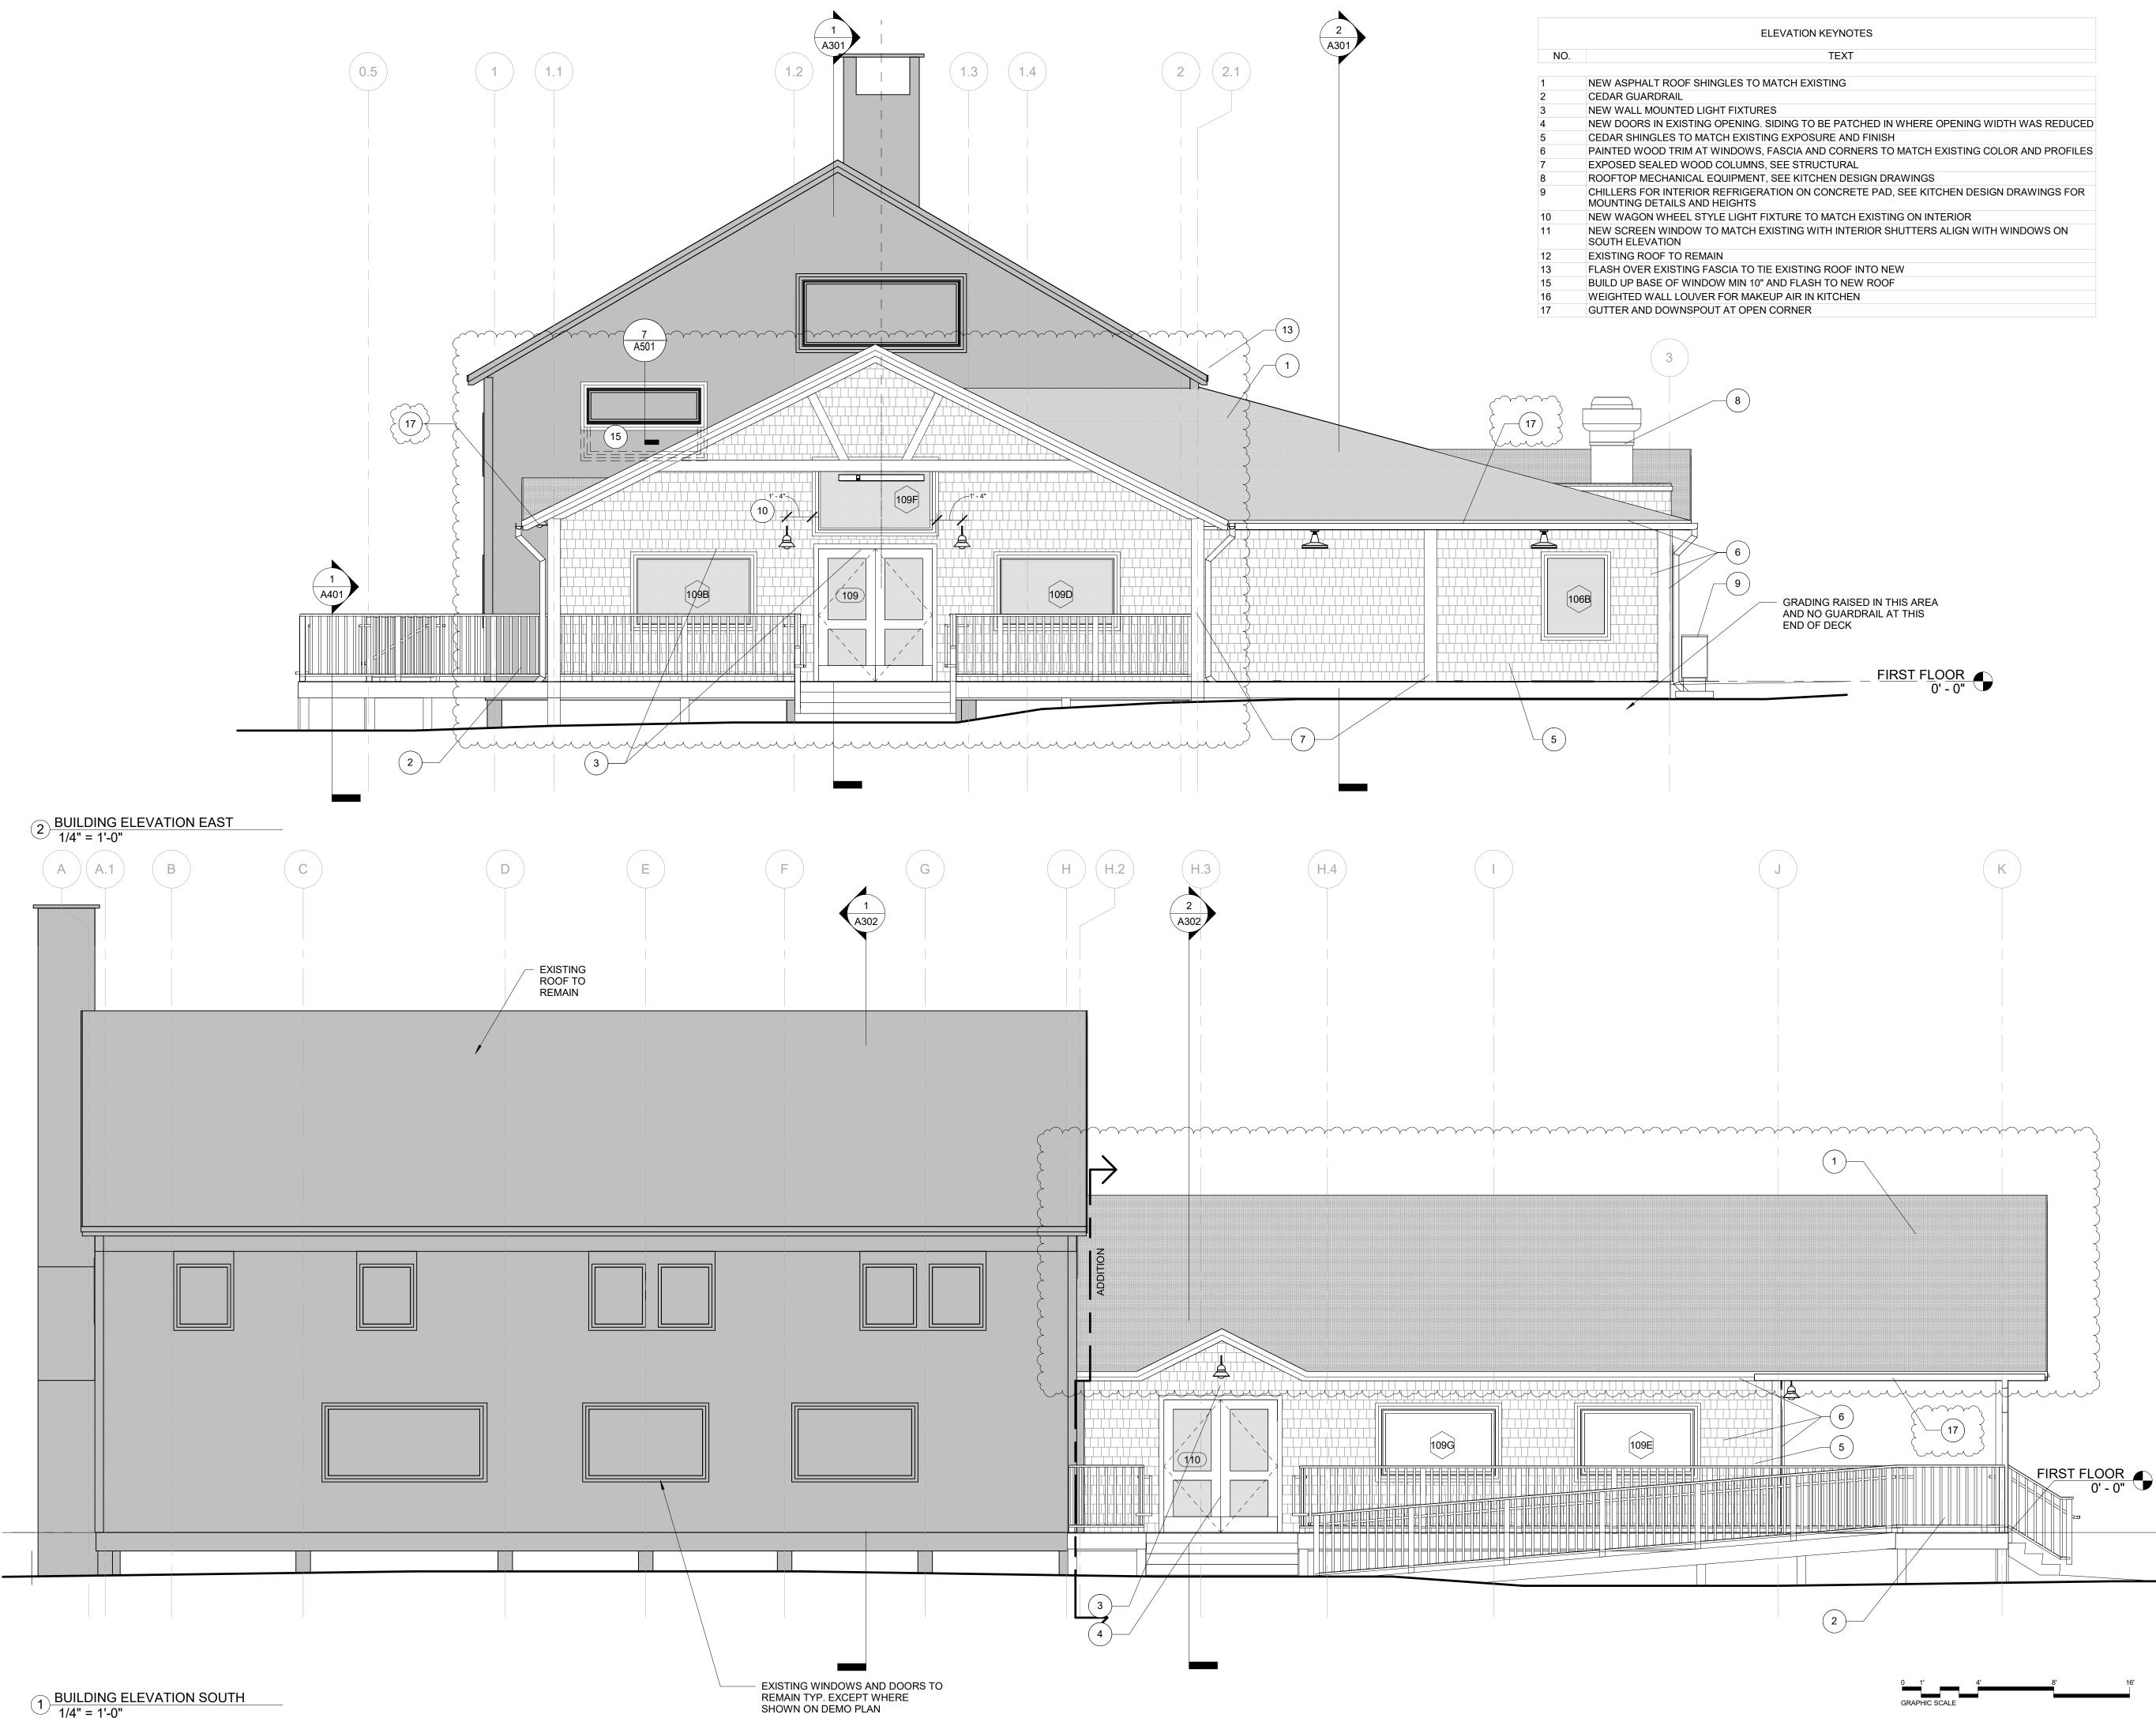
05/10/2024 2023-0050 **BULLETIN 1**

EXTERIOR ELEVATIONS NORTH AND WEST

A201





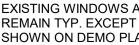


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GENERAL NO	TES		
A. SEE STRUCTURAL DOC ADDITIONAL WORK.	UMENTS FOR		
3. GC SHALL BE RESPONS TEMPORARY SUPPORT AND BRACING AS REQU	, SHORING, IIRED.		
C. WORK TO BE SEQUENC SCHEDULED, AND OTHE COORDINATED WITH O	ERWISE		
D. GC TO PROTECT ADJAC NOT AFFECTED BY CON			
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AREAS OF BUILDING NC THIS SCOPE OF WORK HATCHED FOR GENERA ONLY. SOME MEP WORK REQUIRE INTERVENTIO	ARE SHOWN AL REFERENCE K WILL N BEYOND		
LIMIT OF WORK AREAS.			
DOOR SCHEDULES H. EXISTING WINDOWS AN REMAIN EXCEPT WHER			
SYMBOL LEGE	ND	PROJECT NAME: CAMP TIN DINING H 85 PLAINS RD, RAYMOND, ME 04071 SEAL: SEAL: THIS DRAWING IS THE P SIMONS ARCHITECTS (S TO BE COPIED OR REPR PART OR WHOLE. 2024 © SIMONS ARCHITE	ALL R. SA A ROPERTY OF A) AND IS NOT CODUCED IN
ROOM NUMBER		1 50% DESIGN DEVELOPMENT	10.13.23
DOOR NUMBER	101 (101A)	2 BULLETIN 1	05.10.24
WINDOW NUMBER	101A		
PARTITION TYPE			
PLUMBING FIXTURE	PF-		
EQUIPMENT/ ACCESSORY	AC-	DATE OF ISSUE:	05/10/2024
TAG FLOOR FINISH	WD	PROJECT NUMBER: STATUS:	2023-0050 BULLETIN 1
WALL/BASE FINISH	XY AB	EXTERIO	R
FINISH TAG	WD	ELEVATIO	
KEYNOTE		SOUTH A	

EAST

A202

KEYNOTE

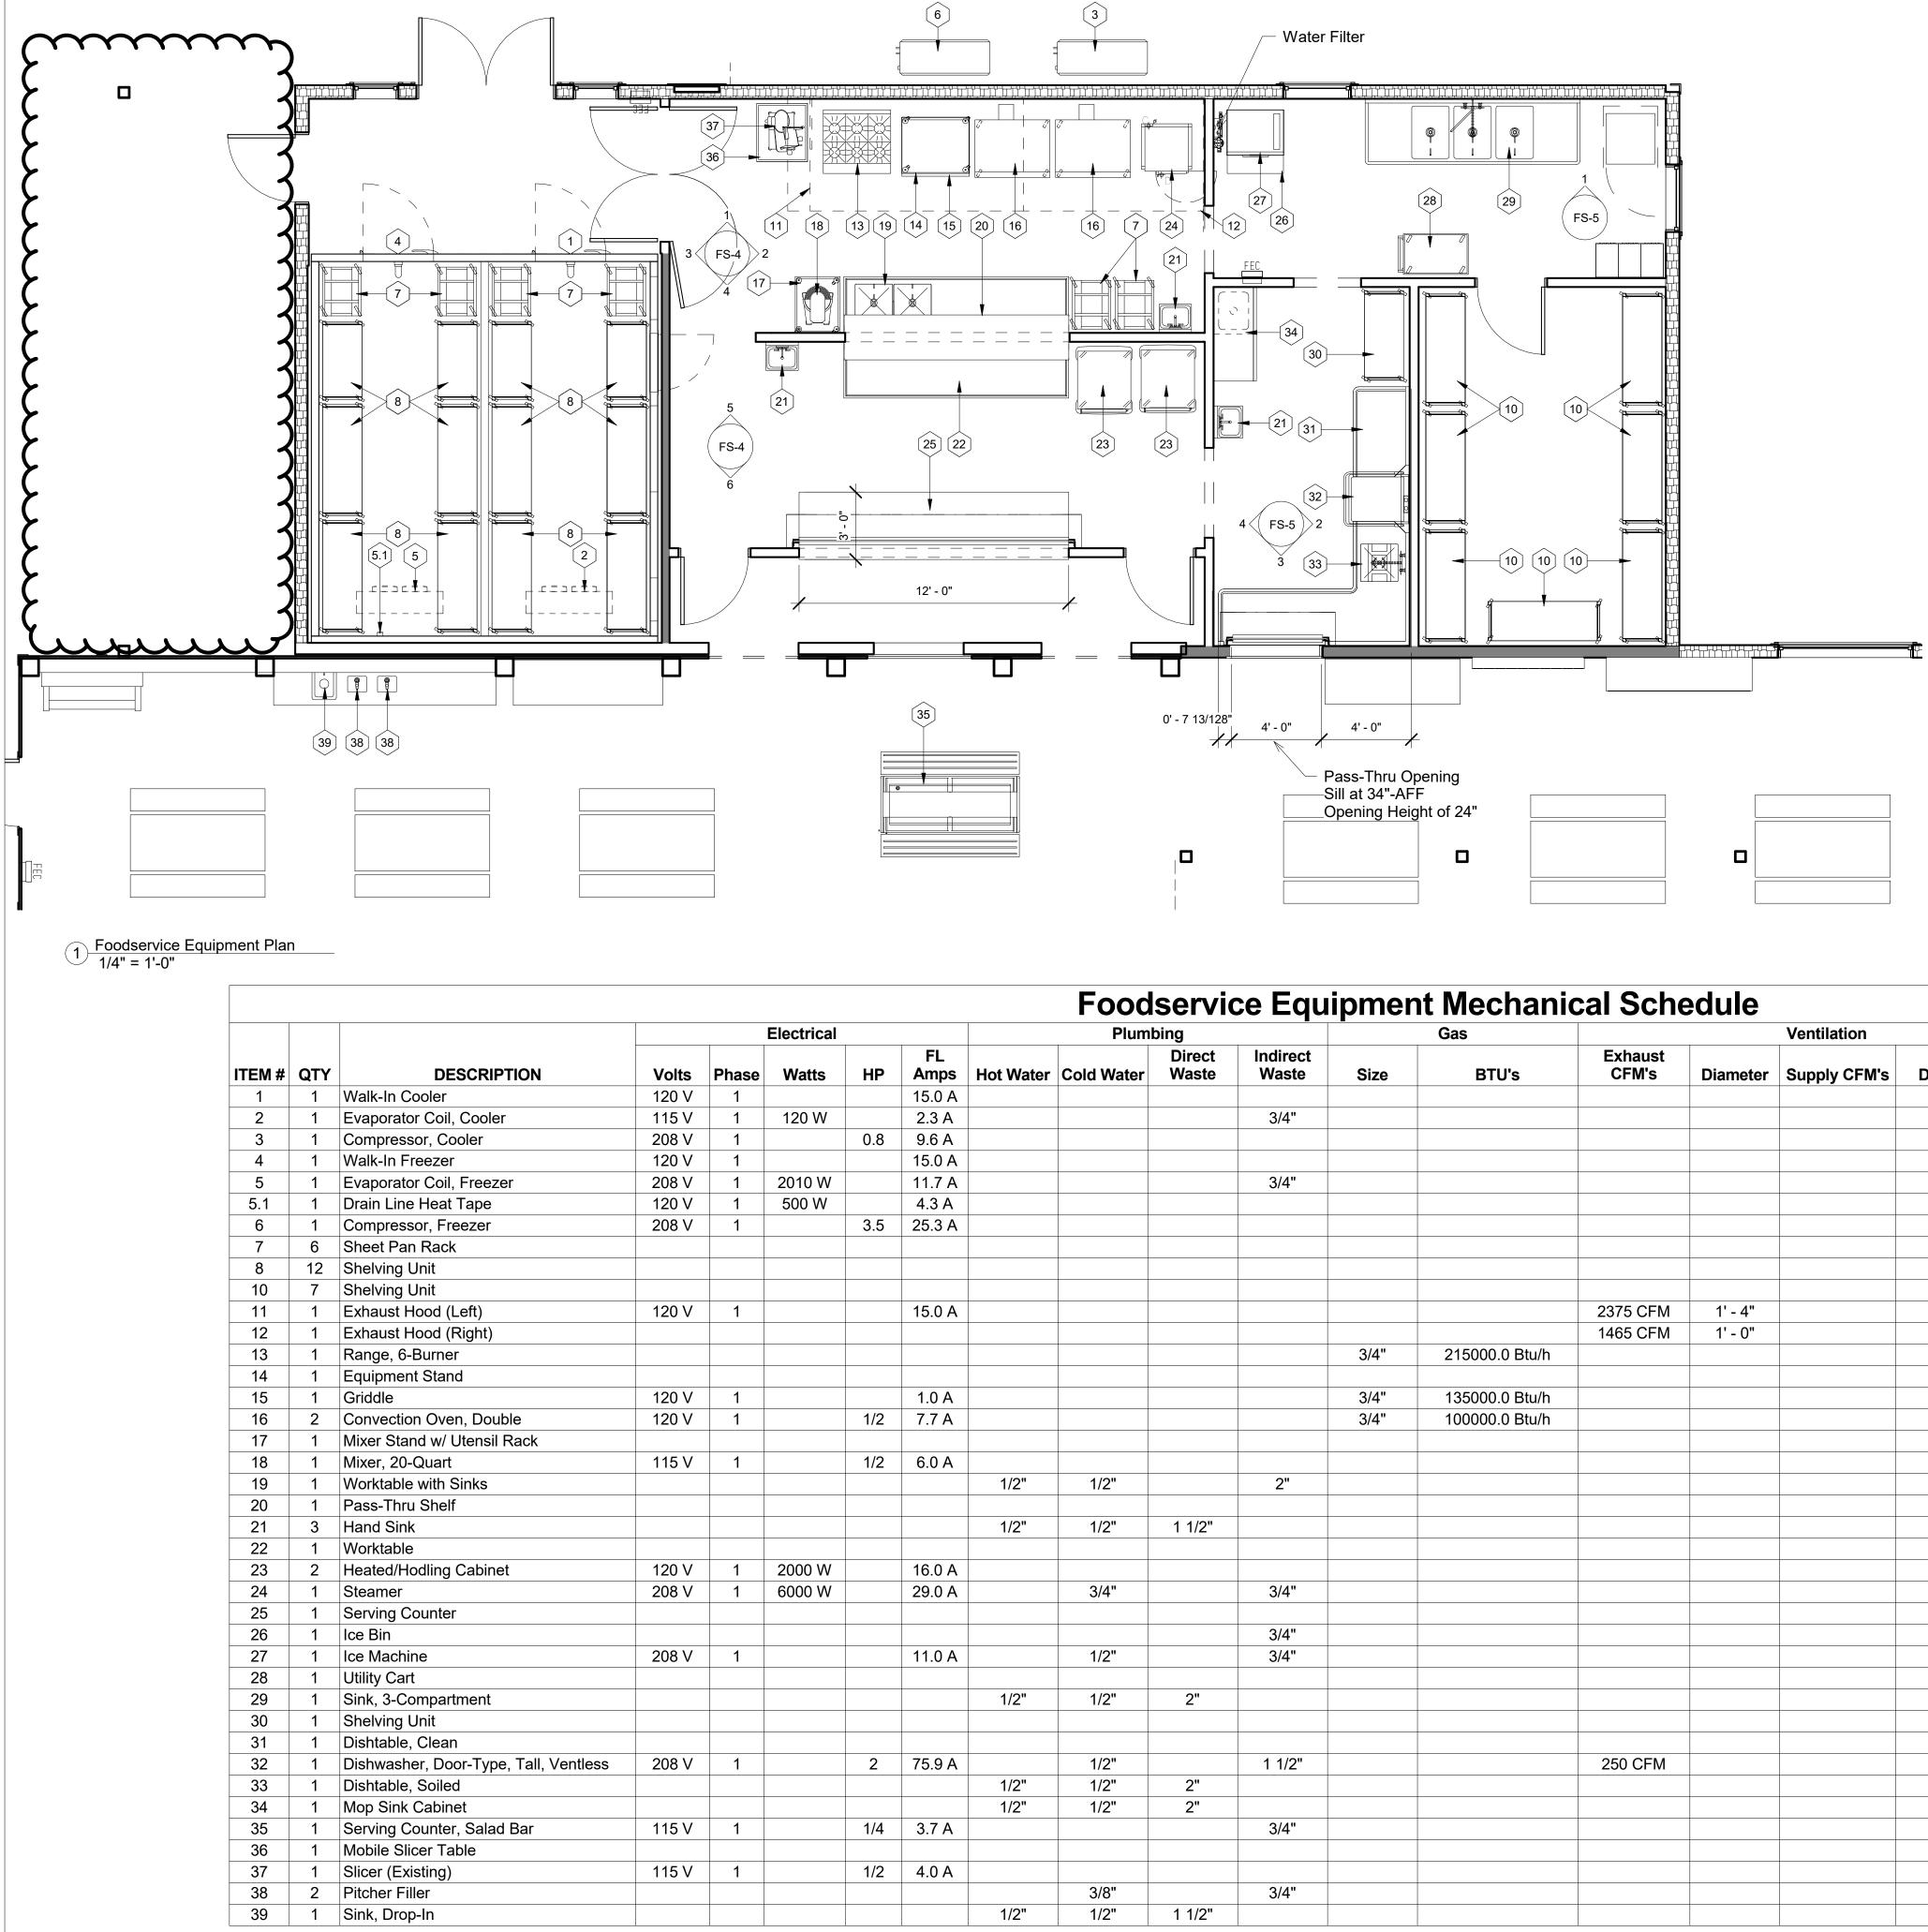

Plumbing			Gas	Ventilation							
ter	Cold Water	Direct Waste	Indirect Waste	Size	BTU's	Exhaust CFM's	Diameter	Supply CFM's	Depth	Width	
			3/4"								
			2/4"								
			3/4"								
						2375 CFM	1' - 4"				
						1465 CFM	1' - 0"				
				3/4"	215000.0 Btu/h						
				3/4"	135000.0 Btu/h						
				3/4"	100000.0 Btu/h						
	4 /01		0"								
	1/2"		2"								
	1/0"	1 1/0"									
	1/2"	1 1/2"									
	3/4"		3/4"								
	0/1		0,1								
			3/4"								
	1/2"		3/4"								
	1/2"	2"									
	1/2"		1 1/2"			250 CFM					
	1/2"	2"									
	1/2"	2"	0./4"								
			3/4"								
	3/8"		3/4"								
	1/2"	1 1/2"	5/4								
	1/2	1 1/2									

Foodservice Equipment Schedule								
ltem #	Qty.	Qty. Description						
1	1	Walk-In Cooler						
2	1	Evaporator Coil, Cooler						
3	1	Compressor, Cooler						
4	1	Walk-In Freezer						
5	1	Evaporator Coil, Freezer						
5.1	1	Drain Line Heat Tape						
6	1	Compressor, Freezer						
7	6	Sheet Pan Rack						
8	12	Shelving Unit						
10	7	Shelving Unit						
11	1	Exhaust Hood (Left)						
12	1	Exhaust Hood (Right)						
13	1	Range, 6-Burner						
14	1	Equipment Stand						
15	1	Griddle						
16	2	Convection Oven, Double						
17	1	Mixer Stand w/ Utensil Rack						
18	1	Mixer, 20-Quart						
19	1	Worktable with Sinks						
20	1	Pass-Thru Shelf						
21	3	Hand Sink						
22	1	Worktable						
23	2	Heated/Hodling Cabinet						
24	1	Steamer						
25	1	Serving Counter						
26	1	Ice Bin						
27	1	Ice Machine						
28	1	Utility Cart						
29	1	Sink, 3-Compartment						
30	1	Shelving Unit						
31	1	Dishtable, Clean						
32	1	Dishwasher, Door-Type, Tall, Ventless						
33	1	Dishtable, Soiled						
34	1	Mop Sink Cabinet						
35	1	Serving Counter, Salad Bar						
36	1	Mobile Slicer Table						
37	1	Slicer (Existing)						
38	2	Pitcher Filler						
39	1	Sink, Drop-In						

Notes

Ū N CONSULTING I Iting and Design e 17-301C 04005 36 Maine kaymond, 0 an B Ŕ σ Ω du 0 Ř Plains Ca S 00 Z Ō Project #: 2023-0050 Drawn By: TJM Date: 05/10/2024 Status: BULLETIN 1 Drawing Name FOODSERVICE EQUIPMENT PLAN & SCHEDULE Sheet Number

Scale: 1/4" = 1'-0"